

Public Works Committee

4:30 p.m., April 12, 2021 Council Chambers 1207 Palm Boulevard, Isle of Palms, South Carolina

Public Comment:

All citizens who wish to speak during the meeting must email their first and last name, address and topic to rhanna@iop.net no later than 3:00 p.m. the day before the meeting.

Citizens may also provide public comment here: https://www.iop.net/public-comment-form

Agenda

- 1. **Call to order -** and acknowledgement that the press and public have been duly notified of the meeting in accordance with the Freedom of Information Act.
- 2. Approval of previous meeting's minutes March 3, 2021
- 3. Citizens' Comments
- 4. **Department Report –** Director Pitts and Assistant Director Asero
- 5. Old Business
 - a. Update on Phase III Drainage Project, small internal projects and Waterway Boulevard path elevation – Presentation by Thomas & Hutton
 - b. Update on Island Wide Drainage Master Plan RFP
 - c. Update on Non-Standard Service Fund eligible projects for FY22, FY23 and FY24

6. New Business

- Consideration of change order in the amount of \$43,300 to the Thomas & Hutton contract for additional permitting efforts for the Phase III Drainage project
- b. Consideration of replacement of 2003 Mack Flatbed in the amount of \$97,260 [FY21 Budget, Public Works, Capital Projects Fund, \$40,000; Hospitality Tax Fund, \$40,000 and State Accommodations Fund, \$40,000]
- c. Consideration of FY22 CTC "C" funding request of eligible new construction projects
- d. Discussion of the creation of an Environmental Advisory Committee
- e. Discussion of beach traffic and parking
- 7. Miscellaneous Business

Next Meeting Date: 4:30 p.m., Wednesday, May 5, 2021

- 8. Executive Session If needed
- 9. Adjournment



PUBLIC WORKS COMMITTEE

4:30pm, Wednesday, March 3, 2021 Virtual Meeting via Zoom call due to COVID-19 Pandemic broadcasted live on YouTube: https://www.youtube.com/user/cityofisleofpalms

MINUTES

1. Call to order

Present: Council members Smith, Streetman, Ward

Staff Present: Asst. Administrator Hanna, Director Pitts, Director Kerr, Asst. Director

Asero

2. Approval of previous meeting's minutes – February 3, 2021

Council Member Streetman made a motion to approve the minutes of the February 3, 2021 meeting, and Council Member Smith seconded the motion. The motion passed unanimously.

3. **Citizens' Comments** -- none

4. Department Reports – Director Pitts and Assistant Director Asero

Director Pitts reported that garbage and yard debris totals for January were as expected but miscellaneous debris collection was higher than normal. Vehicle maintenance is over budget for January, but Director Pitts said the year will end within budget.

Asst. Director Asero reported that Eadie's has been on the island working at two places on 29th Avenue, 45th Avenue, and the municipal lot. Charleston County repaired drainage at 25th Avenue. The pipe installed at Driftwood Lane is complete.

Facilities maintenance work included exterior painting at the Public Works building, fencing repair at the Public Safety building, installation of parking stops in the municipal lots, and repair of the backflow preventer and waterline at the watersports dock.

He also detailed the work completed at the Front Beach, including the installation of the new patio, repairs of the brick paver aprons on Ocean Boulevard, Comcast's replacement of broken utility boxes, and the removal of old Front Beach streetlights.

Debris was cleaned from the Connector by Public Works staff and the sweeping contractor. Public Works staff also installed ROC at Forest Trail and completed heavy pruning at the 40th Avenue beach access.

Council Member Smith asked about the possibility of photo documenting the debris from the Connector by the Public Works staff. Director Pitts said that time does not always allow for taking pictures of the debris. During the busy season, Fire and Police staff also pickup debris.

5. Old Business

A. Update on Phase III Drainage Project, small internal projects, and Waterway Boulevard path elevation – presentation by Thomas & Hutton

Director Kerr reported that Thomas & Hutton has submitted four of five permits for the larger outfall projects. Thomas & Hutton has received positive feedback from OCRM and the Army Corps of Engineers. City staff continues to work with Wild Dunes on aligning easements for the 41st Avenue outfall portion of the project.

Construction on the Forest Trail and 30th Avenue outfalls is expected to begin in September 2021 and take approximately 9 months to complete. Work on the 41st Avenue outfall is expected to begin in September 2022 and be completed in early 2023.

Regarding the smaller internal projects, Director Kerr said Gulfstream is working on three of those projects at 41st Avenue.

Staff recently received the cost estimates from Thomas & Hutton for the Waterway Boulevard improvements. The estimate is higher than expected, but he said it also needs more study to understand how much additional is required from the City. Director Kerr said lighting the path was not part of the estimate and that may not be something Thomas & Hutton could do as part of their work.

B. Discussion of Dominion Energy's Non-Standard Service Fund and list of eligible projects

Council Member Ward said he would like to make a recommendation to City Council regarding these projects so they can be included in the FY22 budget discussions. Committee members discussed the projects and potential impacts of construction on the community. Committee members agreed to suggest projects 1, 3, and 4 (undergrounding utilities at the City Marina, 21st Avenue, and 14th Avenue) be included in the FY22 budget.

6. New Business

A. Discussion of FY22 Operating Budget for the Public Works Department

Administrator Fragoso reviewed the highlights of the Public Works department operating budget. She said work is still being done on salaries. An increase in the contingency monies available for smaller drainage issues is proposed. \$192,000 is included for the completion of a Masterplan for Drainage. The project will begin in FY21 and be completed in FY22.

Director Pitts suggested looking at fuel and oil costs across all departments as costs have recently risen.

B. Discussion of upcoming Phase IV Drainage – Island-wide Drainage Masterplan RFP

Director Kerr said that once Phase III Drainage is complete the City would like to a plan studying the drainage needs from 30th Avenue to Breach Inlet. In addition, they would like a plan that looks island wide going forward of how the City is to maintain the existing drainage system. This would include looking at how much is put aside annually in contingency, what City codes allow in terms of development, and giving the City a long-range roadmap for overall maintenance. He added the plan would prioritize which projects to work on.

Committee members agreed this is a good proactive approach to the drainage issues on the island. Administrator Fragoso said the Planning Commission will be involved in the process, but ultimately the final recommendation to the full City Council would come from this committee as to the best vendor for this project.

7. Miscellaneous Business

The next meeting of the Public Works Committee will be Wednesday, April 7, 2021 at 4:30pm.

8. Adjournment

Council Member Smith made a motion to adjourn, and Council Member Streetman seconded the motion. The meeting was adjourned at 5:24pm.


Respectfully submitted,


Nicole DeNeane City Clerk

<u>CY2019</u>	<u>CY 2020</u>	CY 2021

Column1			
Jan	223.61	162.77	177.84
Feb	135.17	140.66	146.48
Mar	147.4	212.04	204.6
Apr	241.17	177.52	
May	258.45	252.56	
Jun	294.31	394.38	
Jul	379.48	415.12	
Aug	292.36	270.71	
Sept	188.86	224.87	
Oct	Dorian	196.94	
Nov	153.27	207.44	
Dec	211.04	224.45	

Column1			
Jan	190.61	155.93	183.07
Feb	131.74	157.44	156.06
Mar	174.3	193.74	282.37
Apr	184.59	265.04	
May	202.48	218.67	
Jun	159.4	182.49	
Jul	209.97	198.07	
Aug	249.39	258.37	
Sept	53.11	257.64	
Oct	246.75	252.81	
Nov	165.36	171.54	
Dec	117.26	194.08	

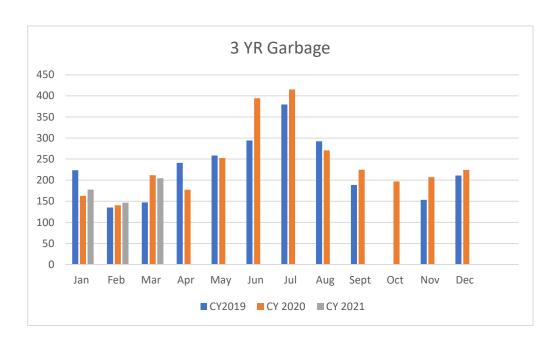

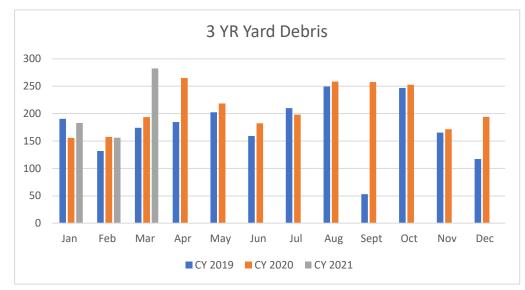

General duties

Sanitation:

39.18 tons of misc. debris in March was transported to Palmetto Commerce Pkwy. **

03/25/2021 AP INV T-BOLT CLAMP & HOSE ASSEMBLY - PWD

03/26/2021 AP INV TUBING ASSEMBLY & (2) HOSE ASSEMBLY

03/30/2021 AP INV 2 "CARLISLE 560443 25X9X12 TIRES - PWD

03/31/202<mark>1 10-4620.5017 END BALANCE</mark>

VEHICLE MAINTENANCE Beginning Budget \$90,000.00 Fund 10 GENERAL FUND 03/01/2021 10-4620.5017 VEHICLE MAINTENANCE BEG. BALANCE 55,581.21 03/04/2021 AP VOID Void Invoice 01W5544.02 00029 - 6,452.42 49,128.79 03/04/2021 AP INV PW-26 MACK TRUCK FROM PWD TO HUGHES MOTO 350.00 49,478.79 03/08/2021 AP INV WELDING OF FLAT BED TRUCK 50,073.62 594.83 03/09/2021 AP INV PW-16 TIRE REPLACEMENT WITH SERVICE CALL 665.27 50,738.89 03/09/2021 AP INV PWD "BULLET ROLLER BAR" 232.76 50,971.65 03/12/2021 AP INV T-BOLT CLAMPS, SUCTION HOSES, ELBOW, ADA 58.02 51,029.67 03/15/2021 AP INV PW-26 2014 MACK - CHECK ENGINE LIGHT -12,132.93 63,162.60 03/19/2021 AP INV PW-26 2014 MACK - CHECK ENGINE LIGHT -1,840.34 65,002.94 03/23/2021 CR RCPT MISCELLANEOUS 64,944.92

REMAINING BALANCE 24,403.14

58.02

132.87

212.05

307.02

16,526.09

65,077.79

65,289.84

65,596.86

65,596.86

Action Items

PUBLIC WORKS MARCH 2021

Assistant director of Storm water and Facilities

Drainage

- Charleston county 25th Ave drainage repair scheduled.
- Charleston county stormwater review plans for new home construction.
- Drainage plan and RFB for 34th and Hartnett.
- Small internal drainage projects.

Facilities

- Painting of front beach white fence by public works.
- Repair of broken irrigation main lines at city hall.
- Repair of broken parking lot lights at the marina.
- Scheduling city hall generator PM service.
- A/C repair at city hall.
- PM filter change on public works fuel dispensers.
- Estimate for concrete pad for generator at the Recreation center.
- Repair of a broken electrical line for the fuel pumps at the marina.
- Repair/reprogram of fuel pump software at the public safety building.
- Estimates for city hall office painting.

Front beach

- Clean up of parking lot / Front beach Ocean Blvd. trash and debris by public works.
- Ordering of supplies and managing cleaning crews for restrooms.
- Removal of ROC from the municipal lot and installing at public works/city hall.
- Second repair of brick paver aprons on Ocean Blvd.
- Painting of city owned street light poles at 14th and Palm Blvd. complete.
- Installation of concrete aprons around the drop inlets at municipal lot B.

Landscaping / Rights of way / Connector / Parks


- Clean up of debris on the connector by public works and sweeping contractor.
- Pleasant places ROW contract amendment due to SCDOT parking plan on Palm Blvd.
- Pleasant places annual pine straw and mulch to front beach.
- Maintenance of Palm Blvd.
- Cutting and clean up of Breech inlet parking lot for SCDOT expansion.


Compactor / Dumpster


- Cleaned compactor pad and recycling area.
- Removal of bulk items left by the PSB compactor.
- Repair of broken hydraulic line and PM service to city compactor.
- Pressure washing of city trash compactor by public works.

Certifications, training and meetings

- Monthly UST testing of marina, public works and public safety building.
- UST annual tank testing public works.

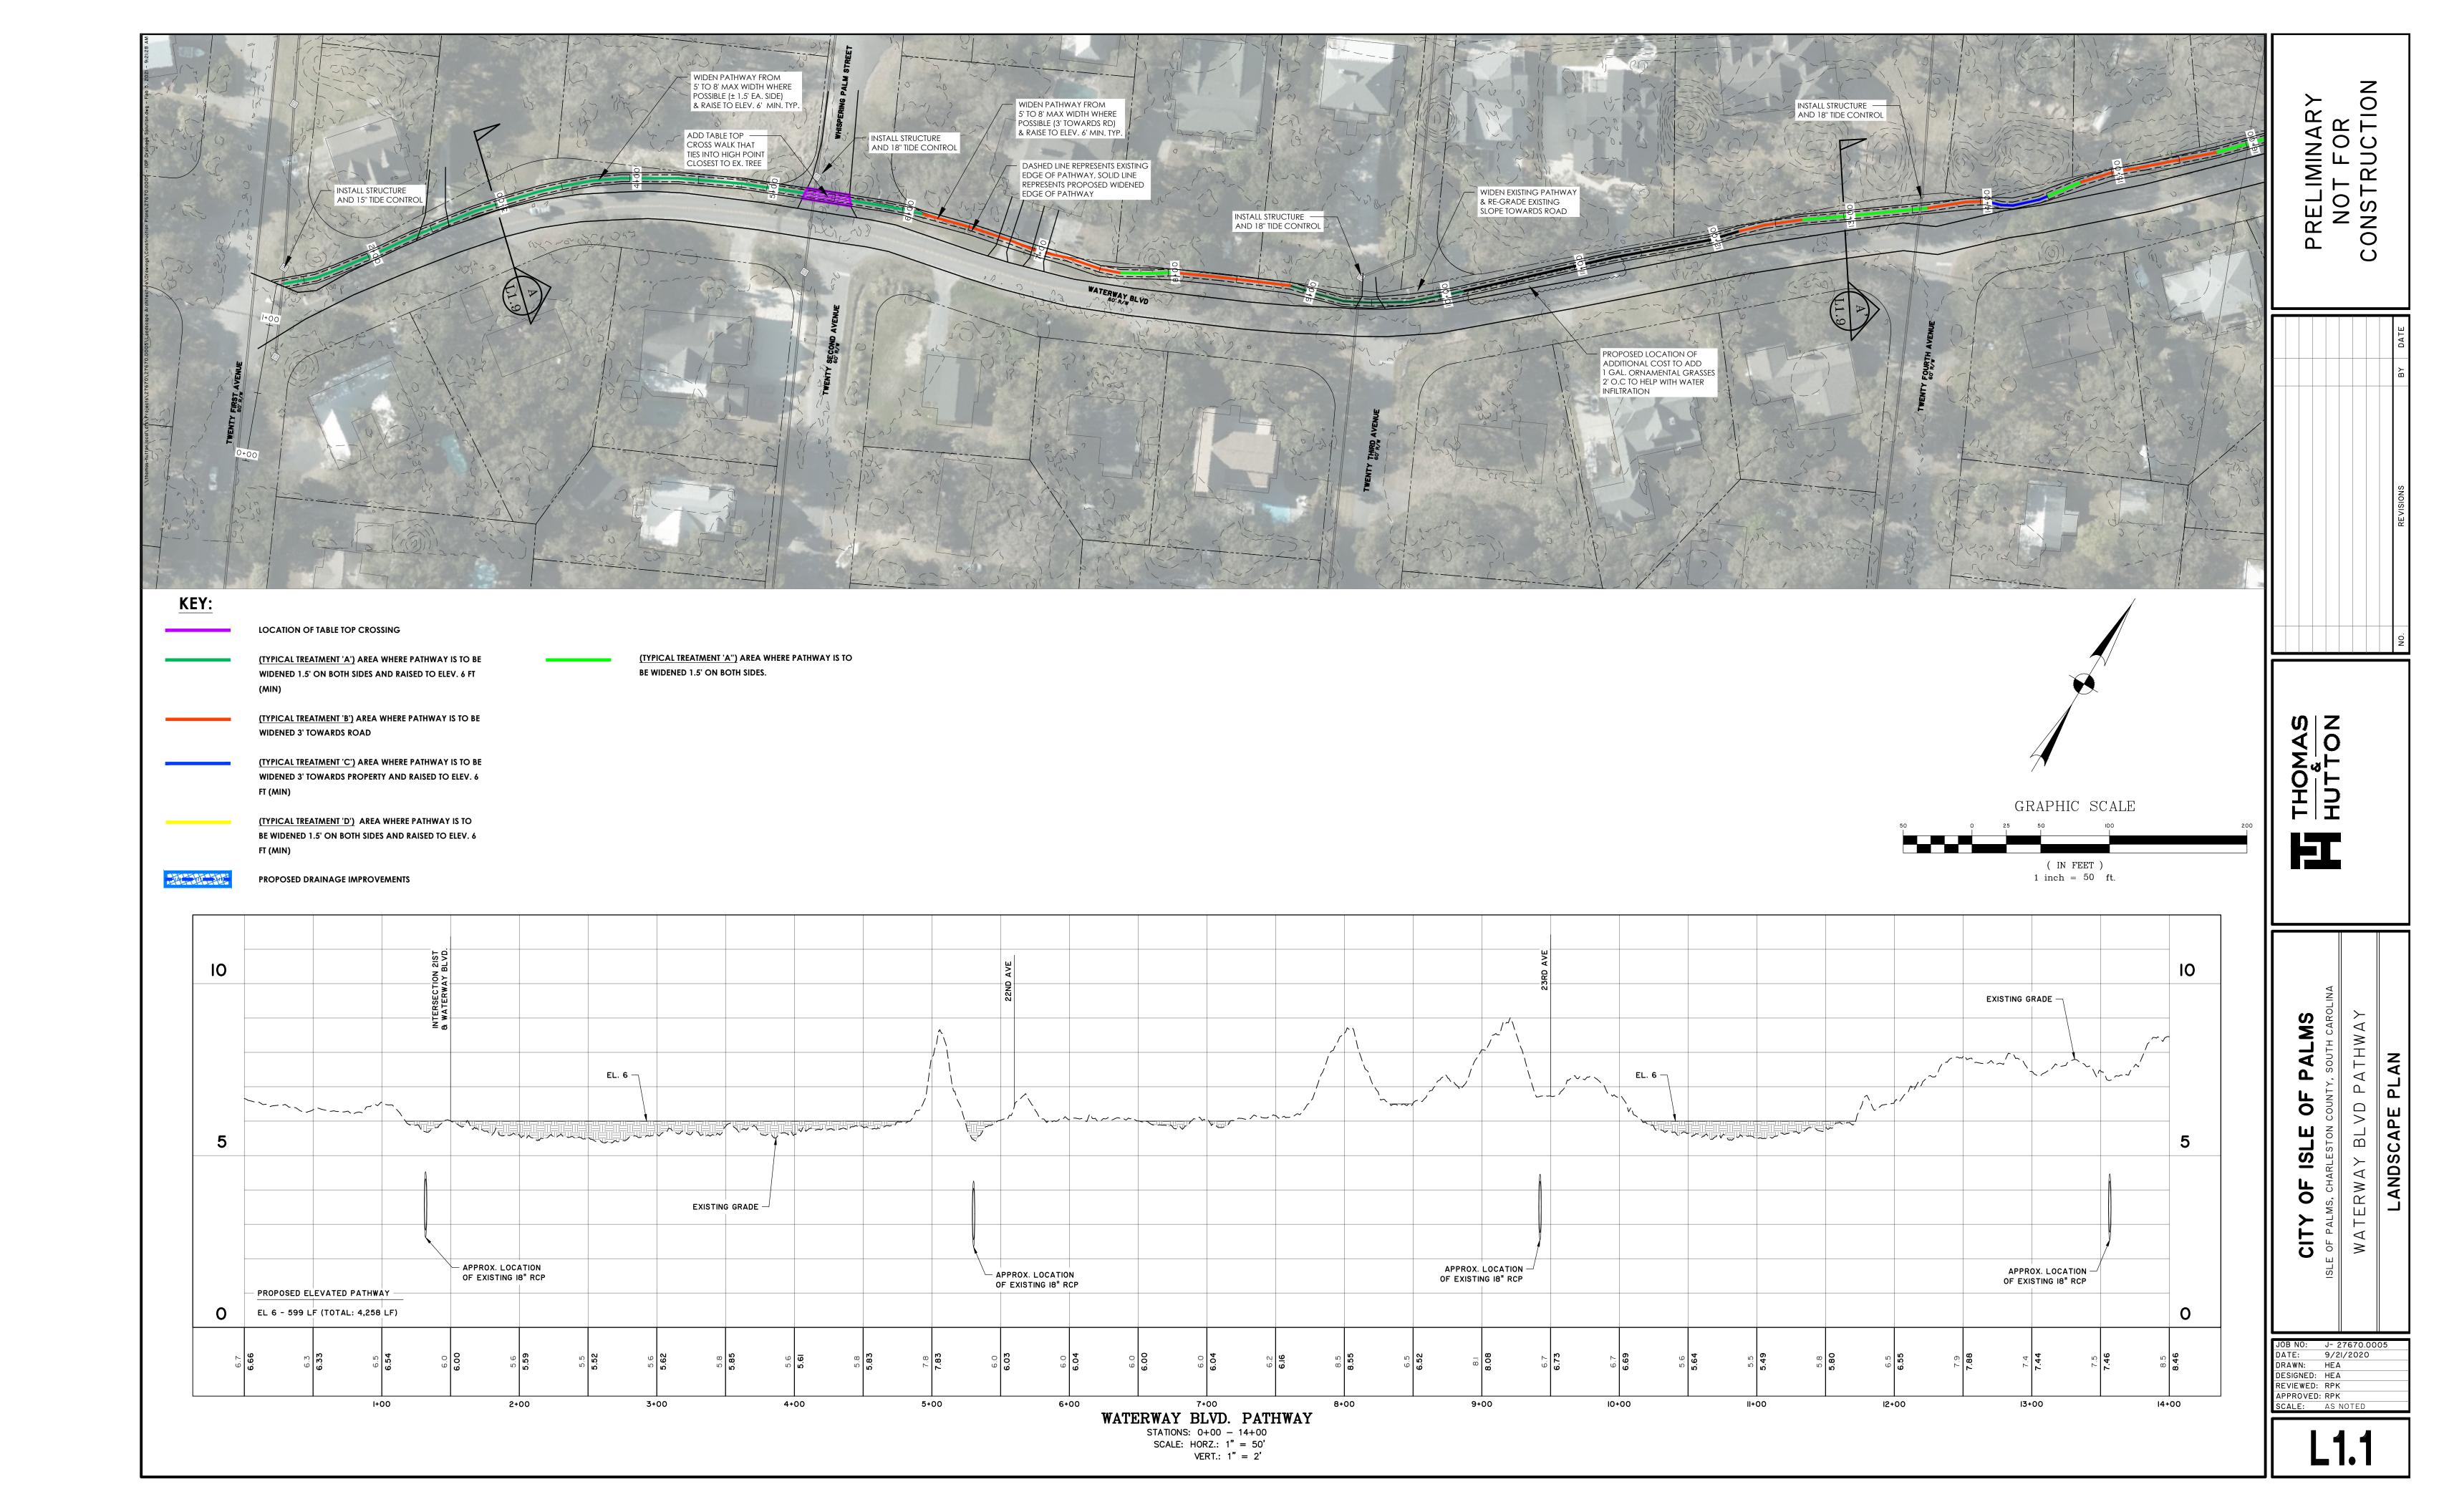

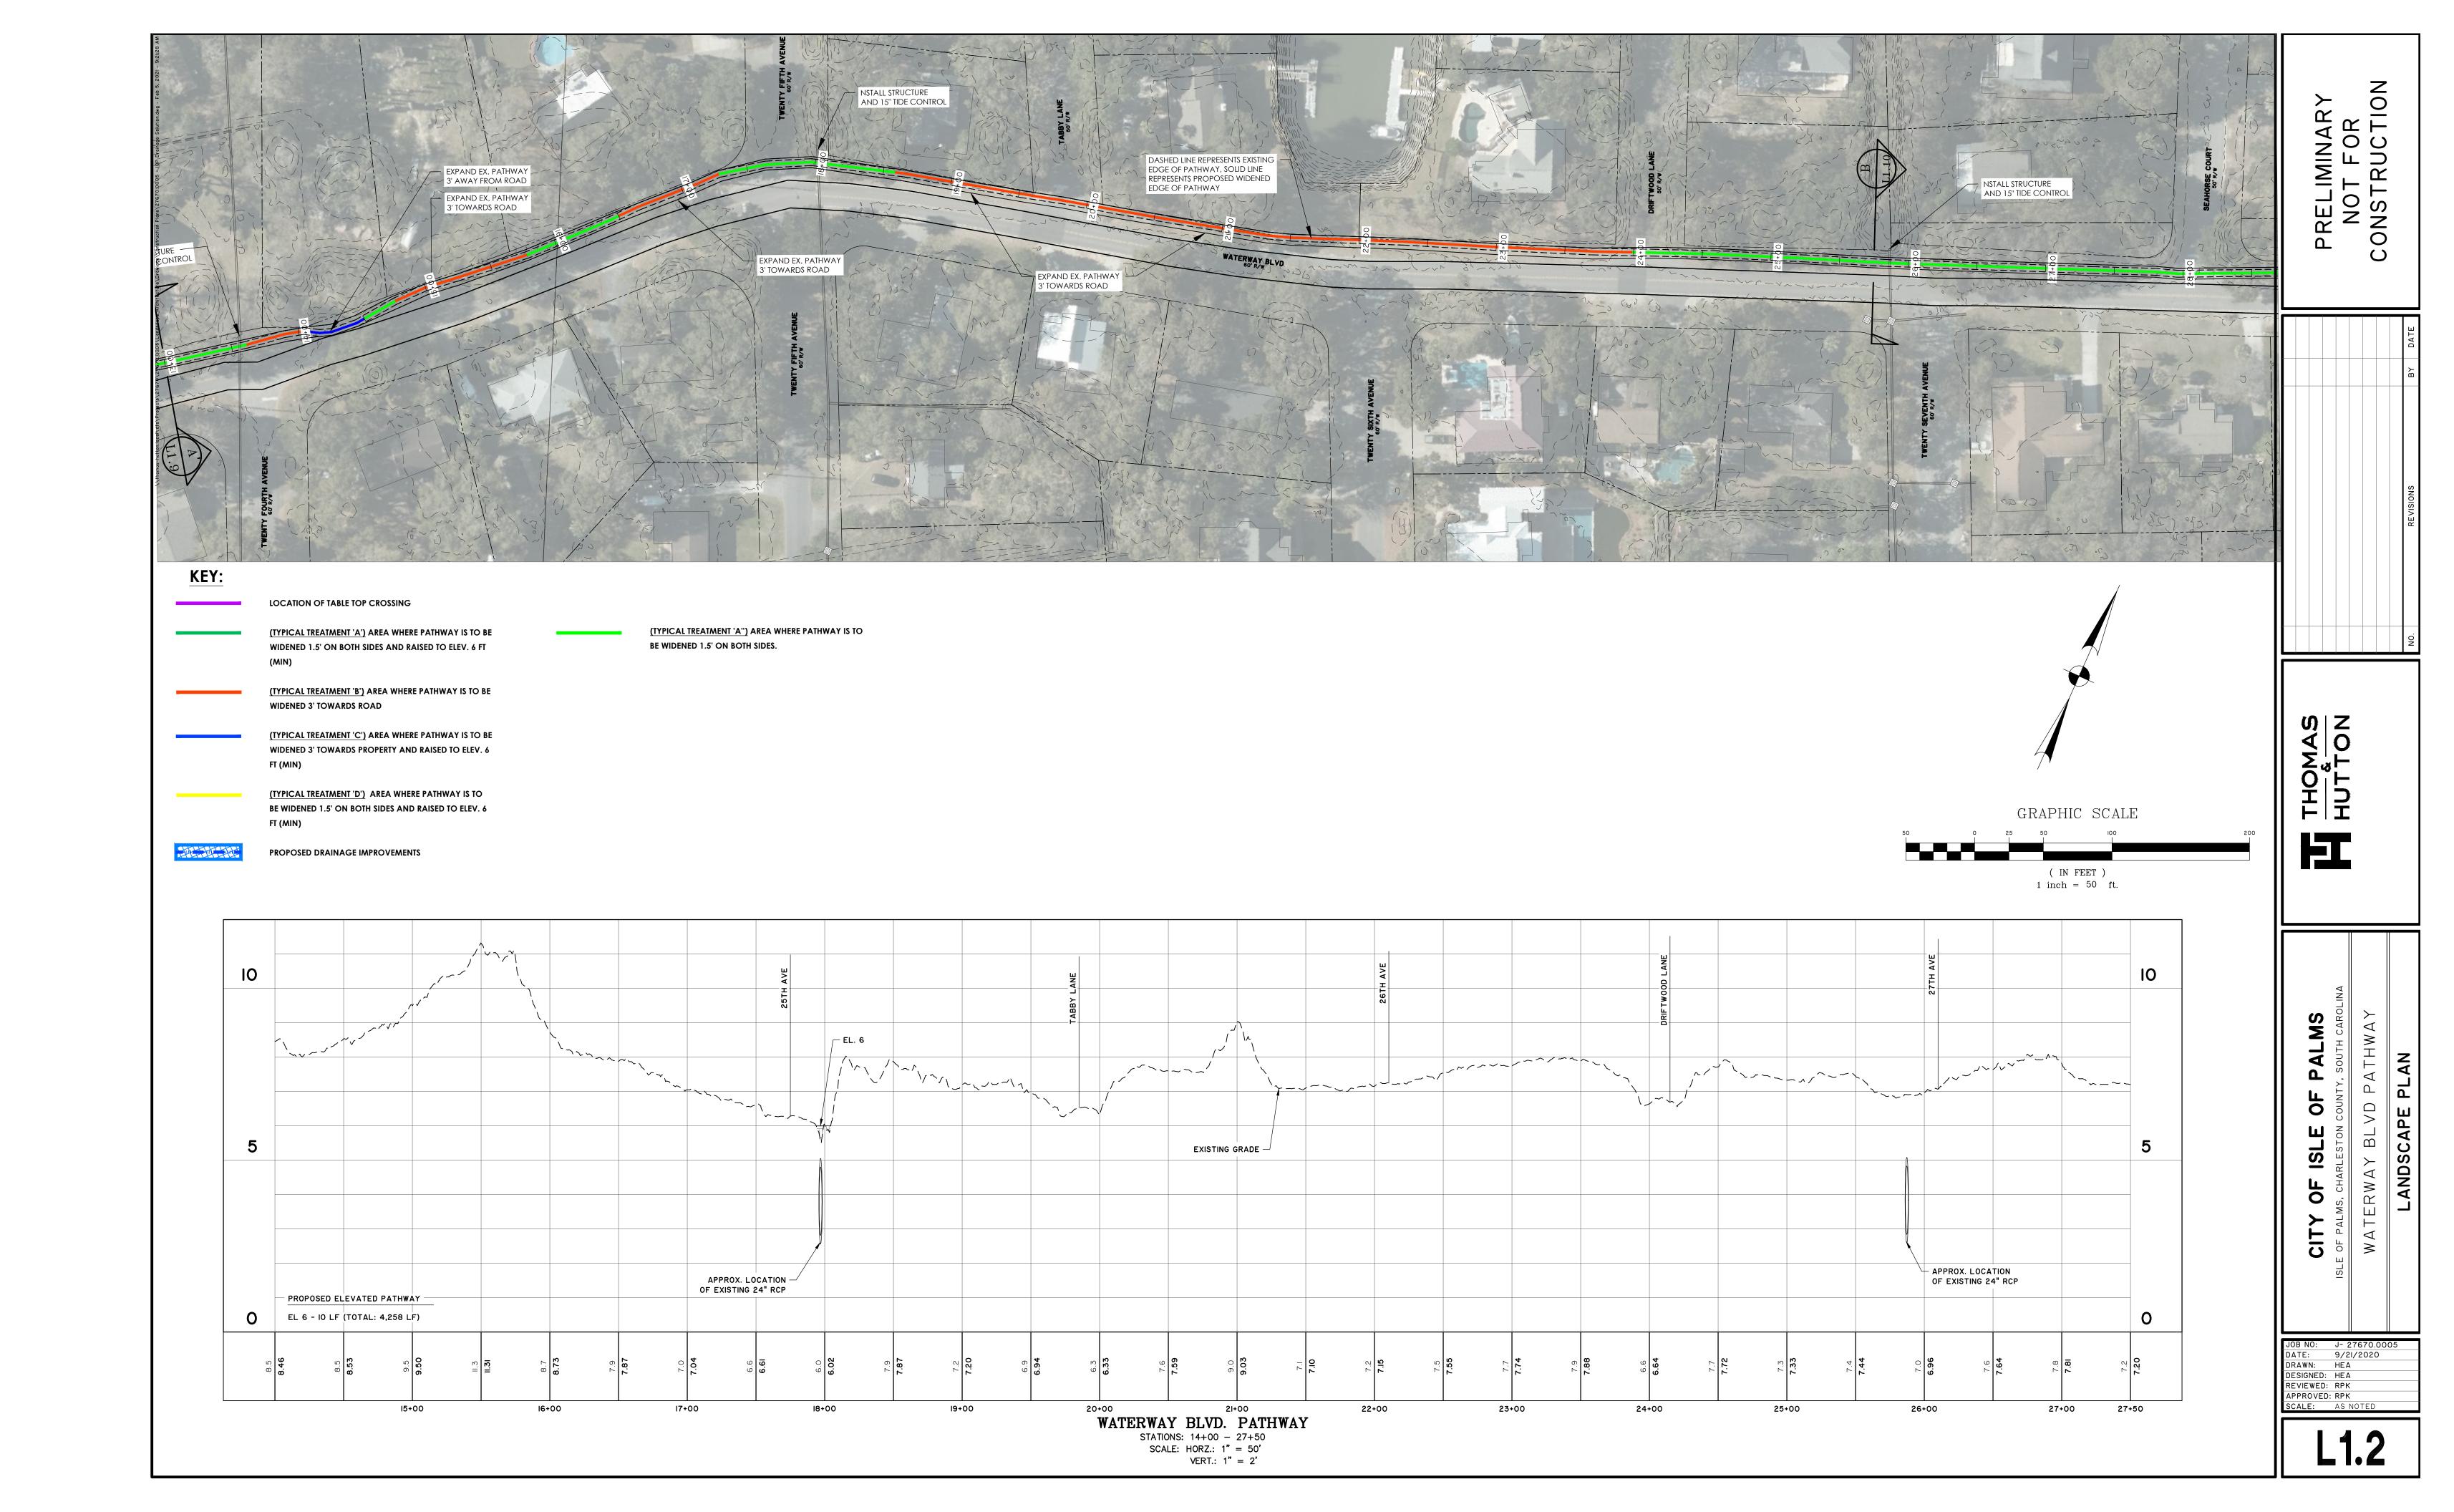

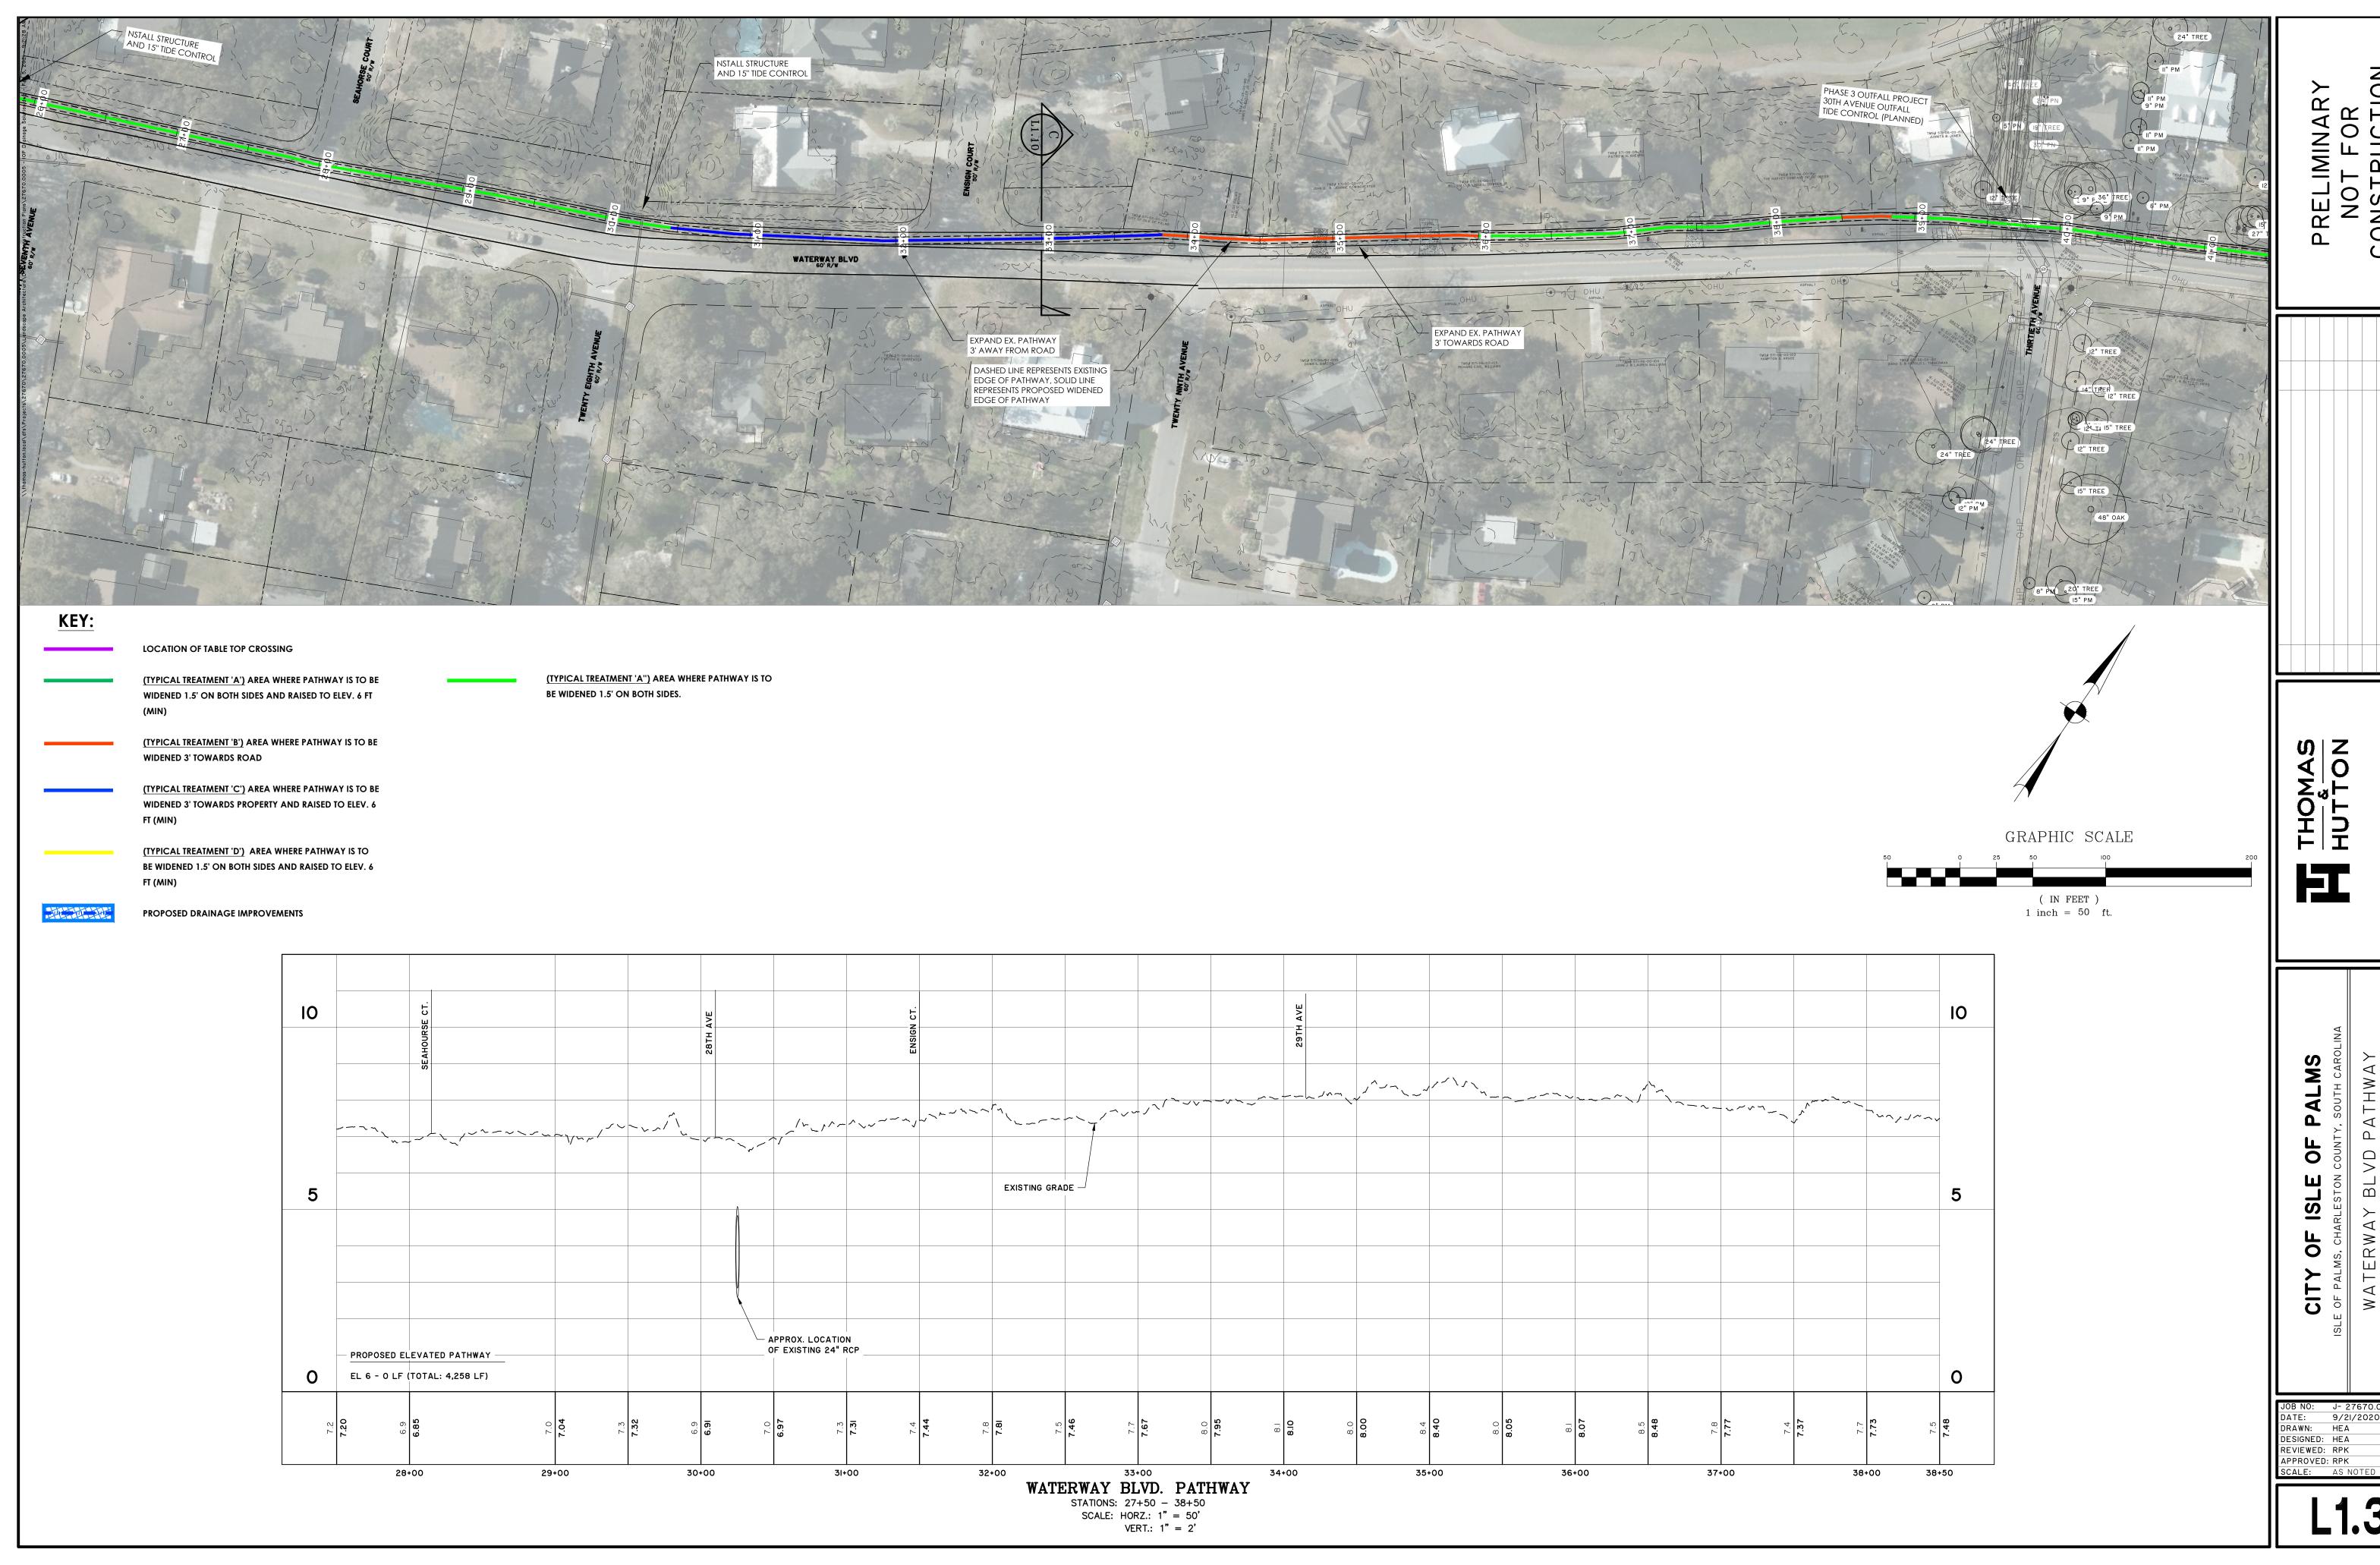



PRELIMINARY NOT FOR CONSTRUCTION

THOMAS HUTTOI

PATHWA' **PLAN**

DRAWN: HEA
DESIGNED: HEA
REVIEWED: RPK APPROVED: RPK

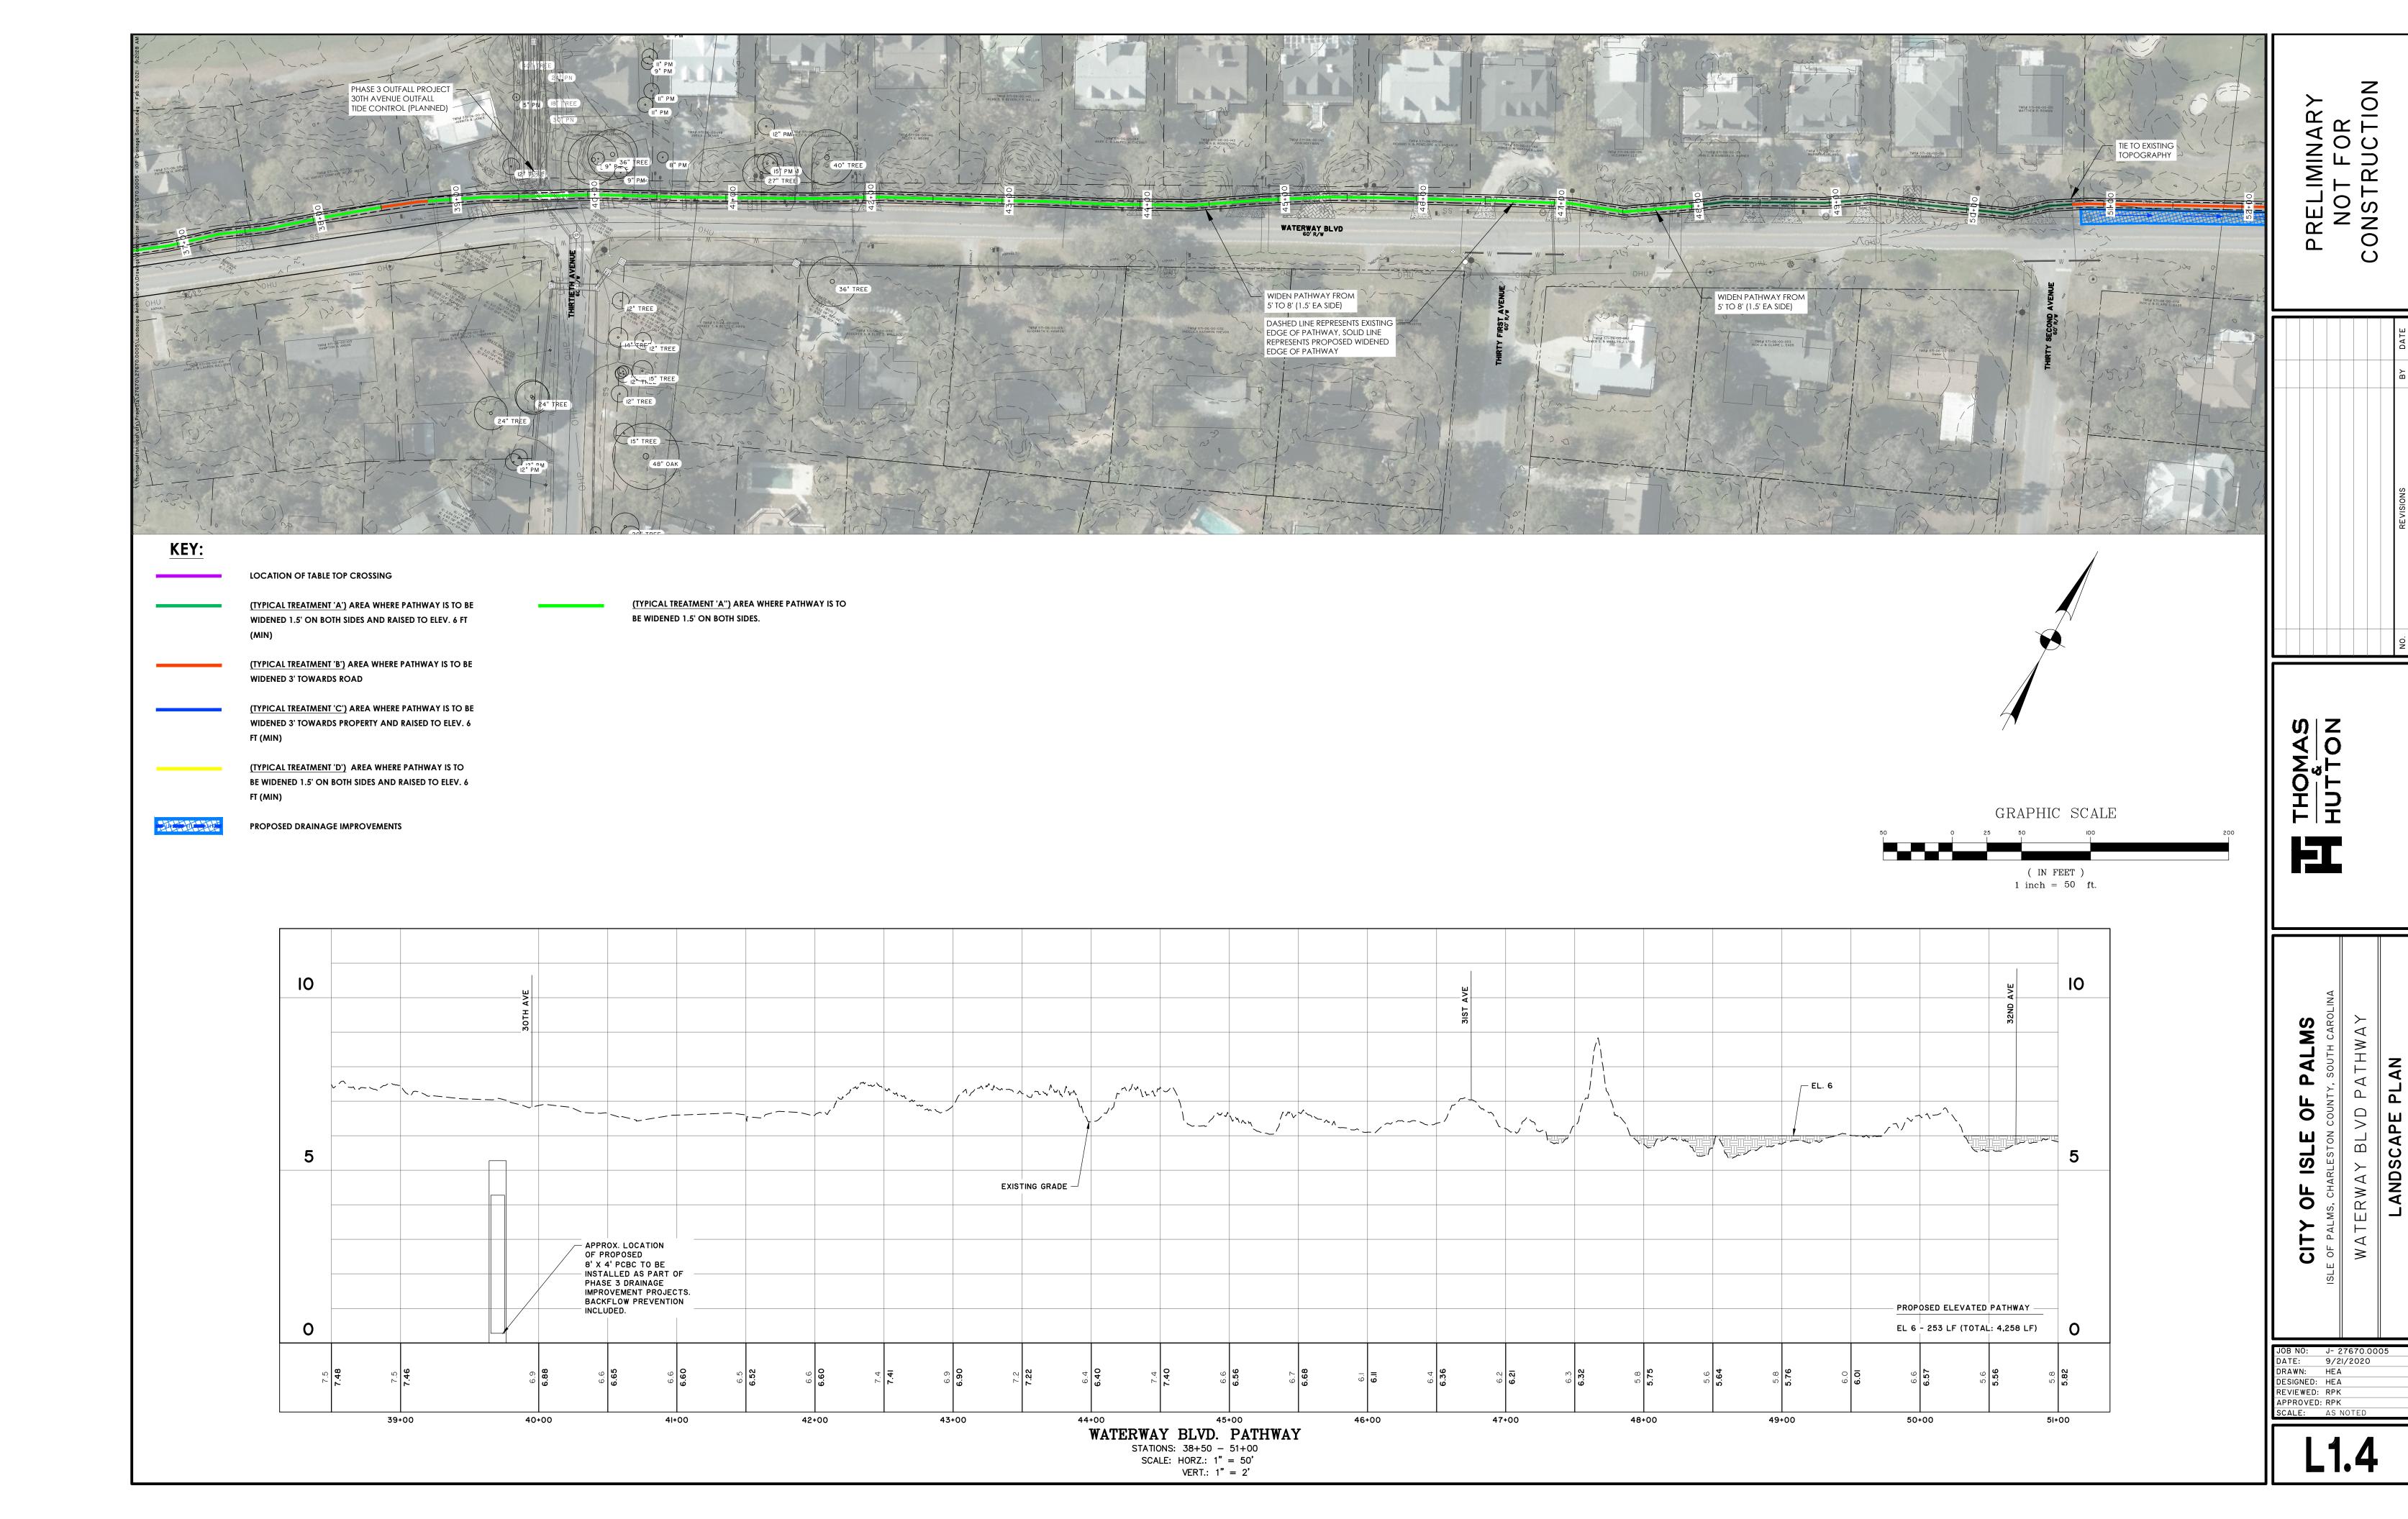


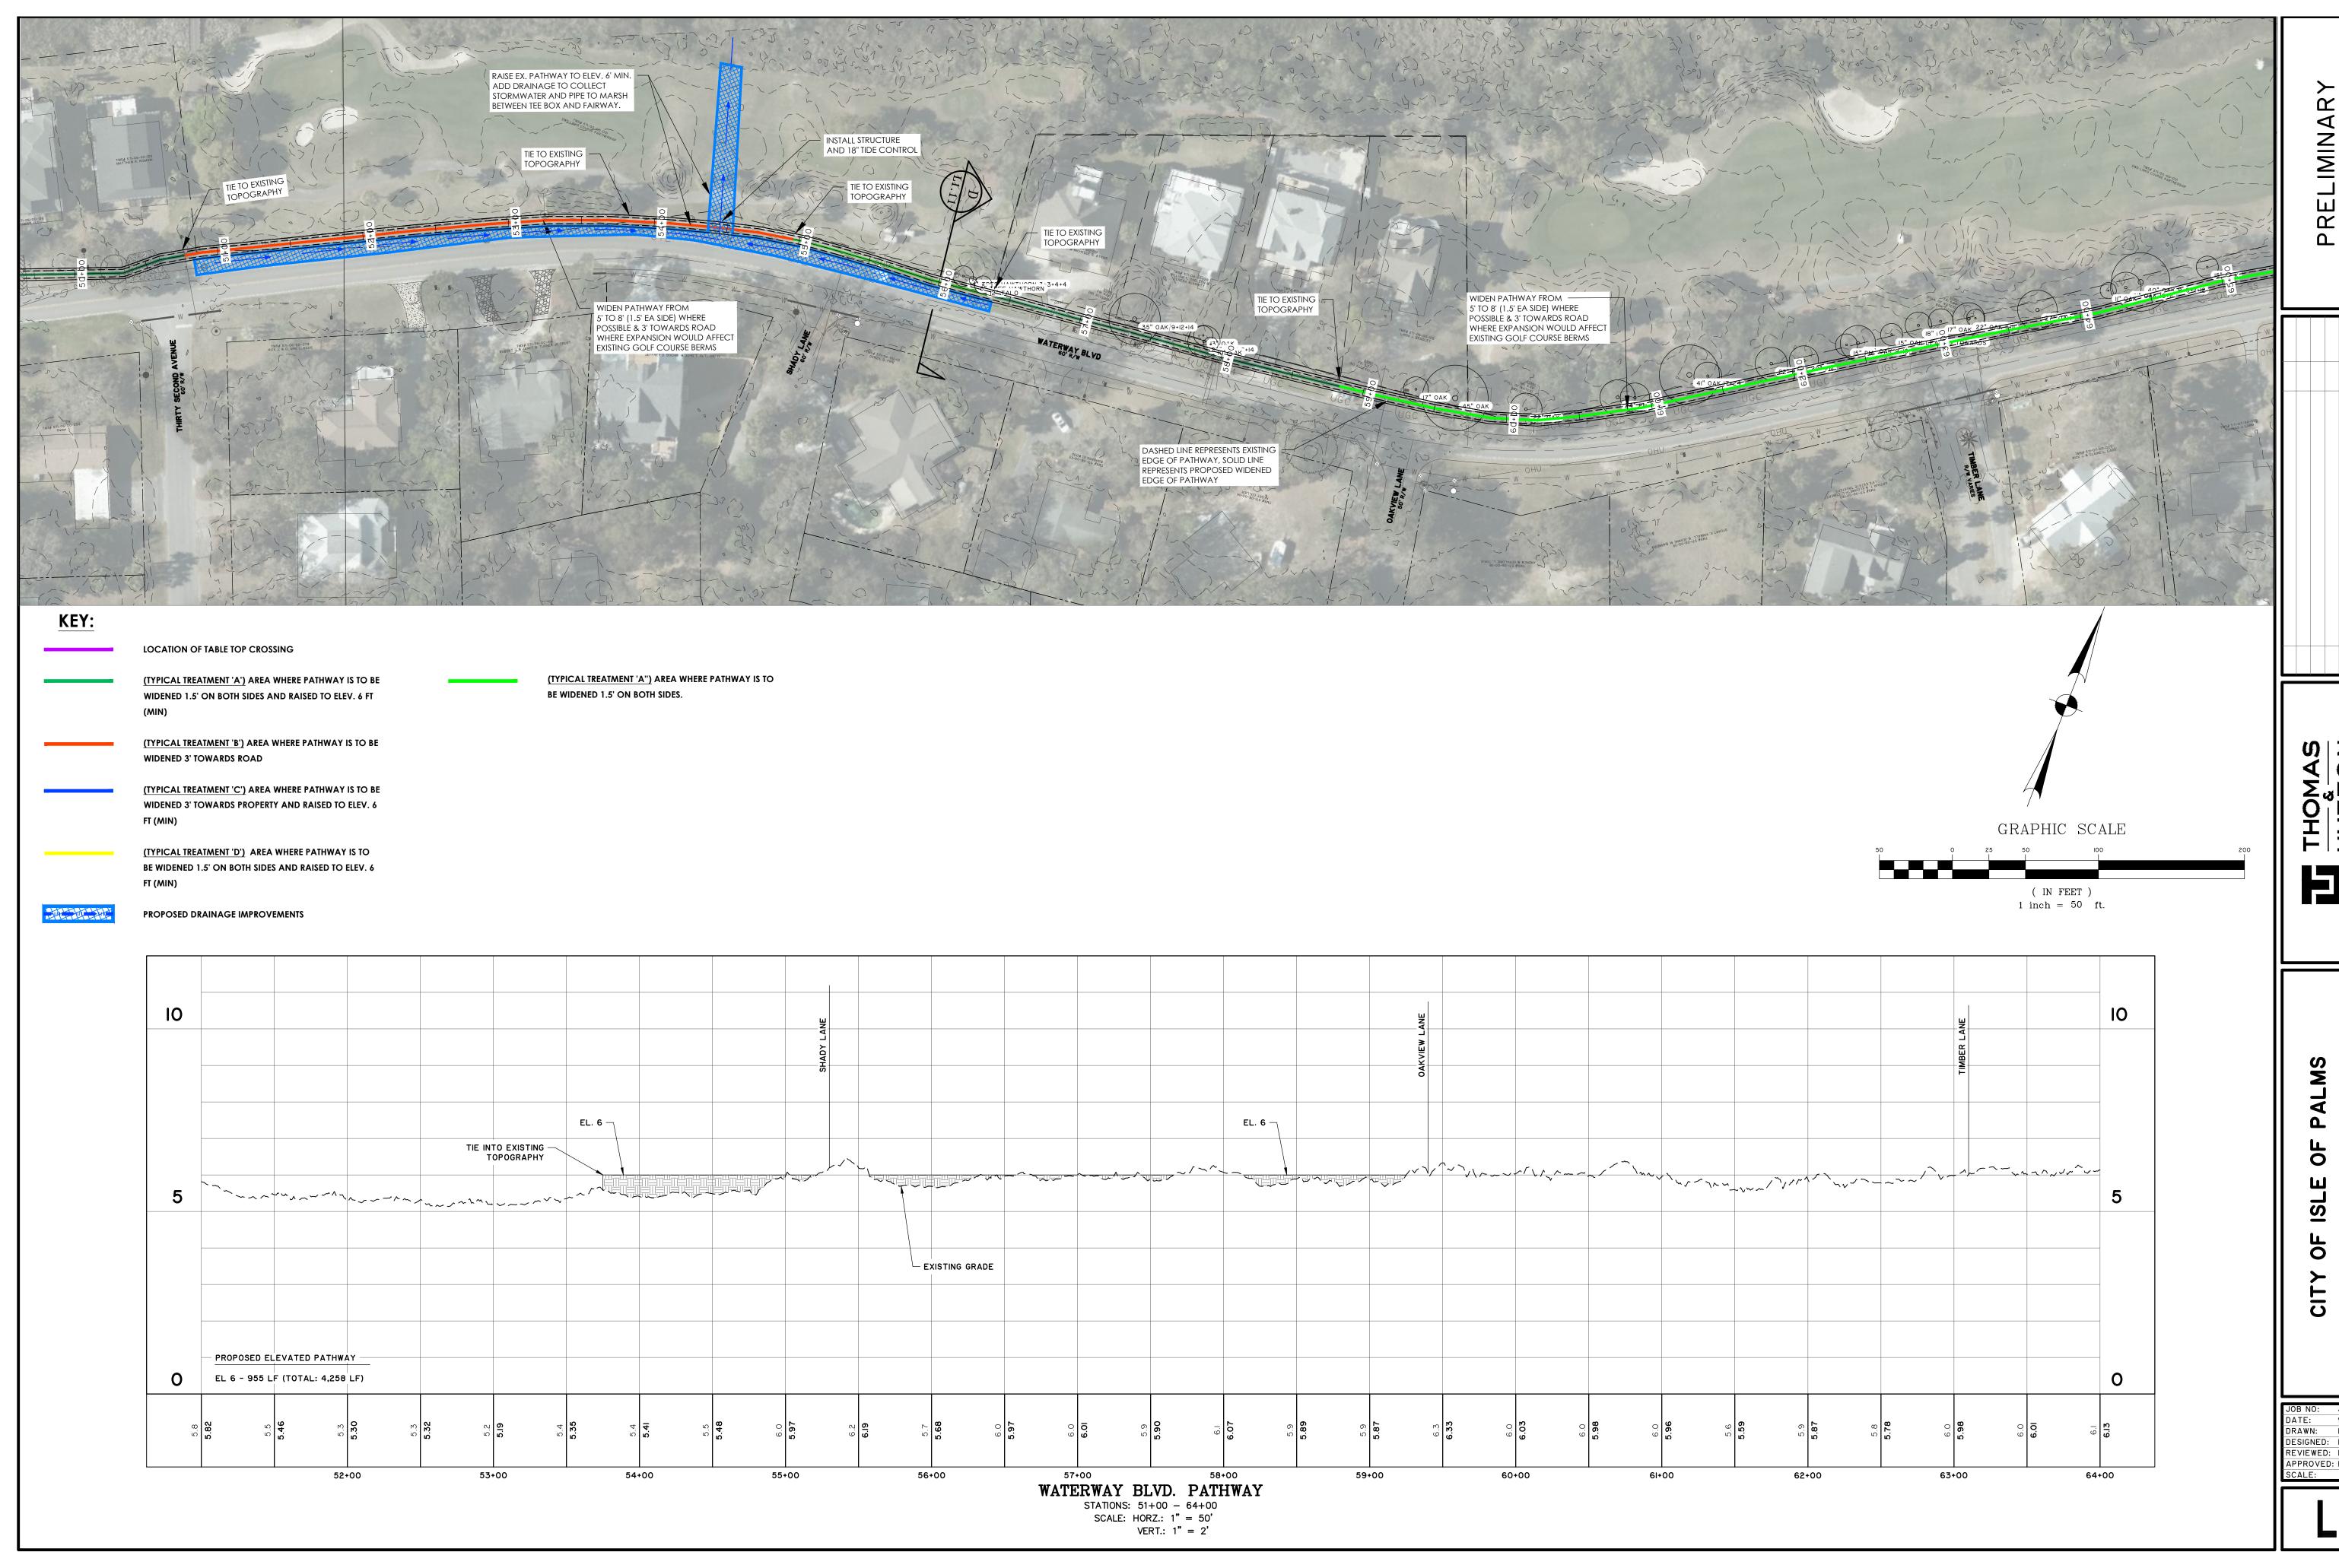


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PATHWA)

DRAWN: HEA
DESIGNED: HEA
REVIEWED: RPK APPROVED: RPK



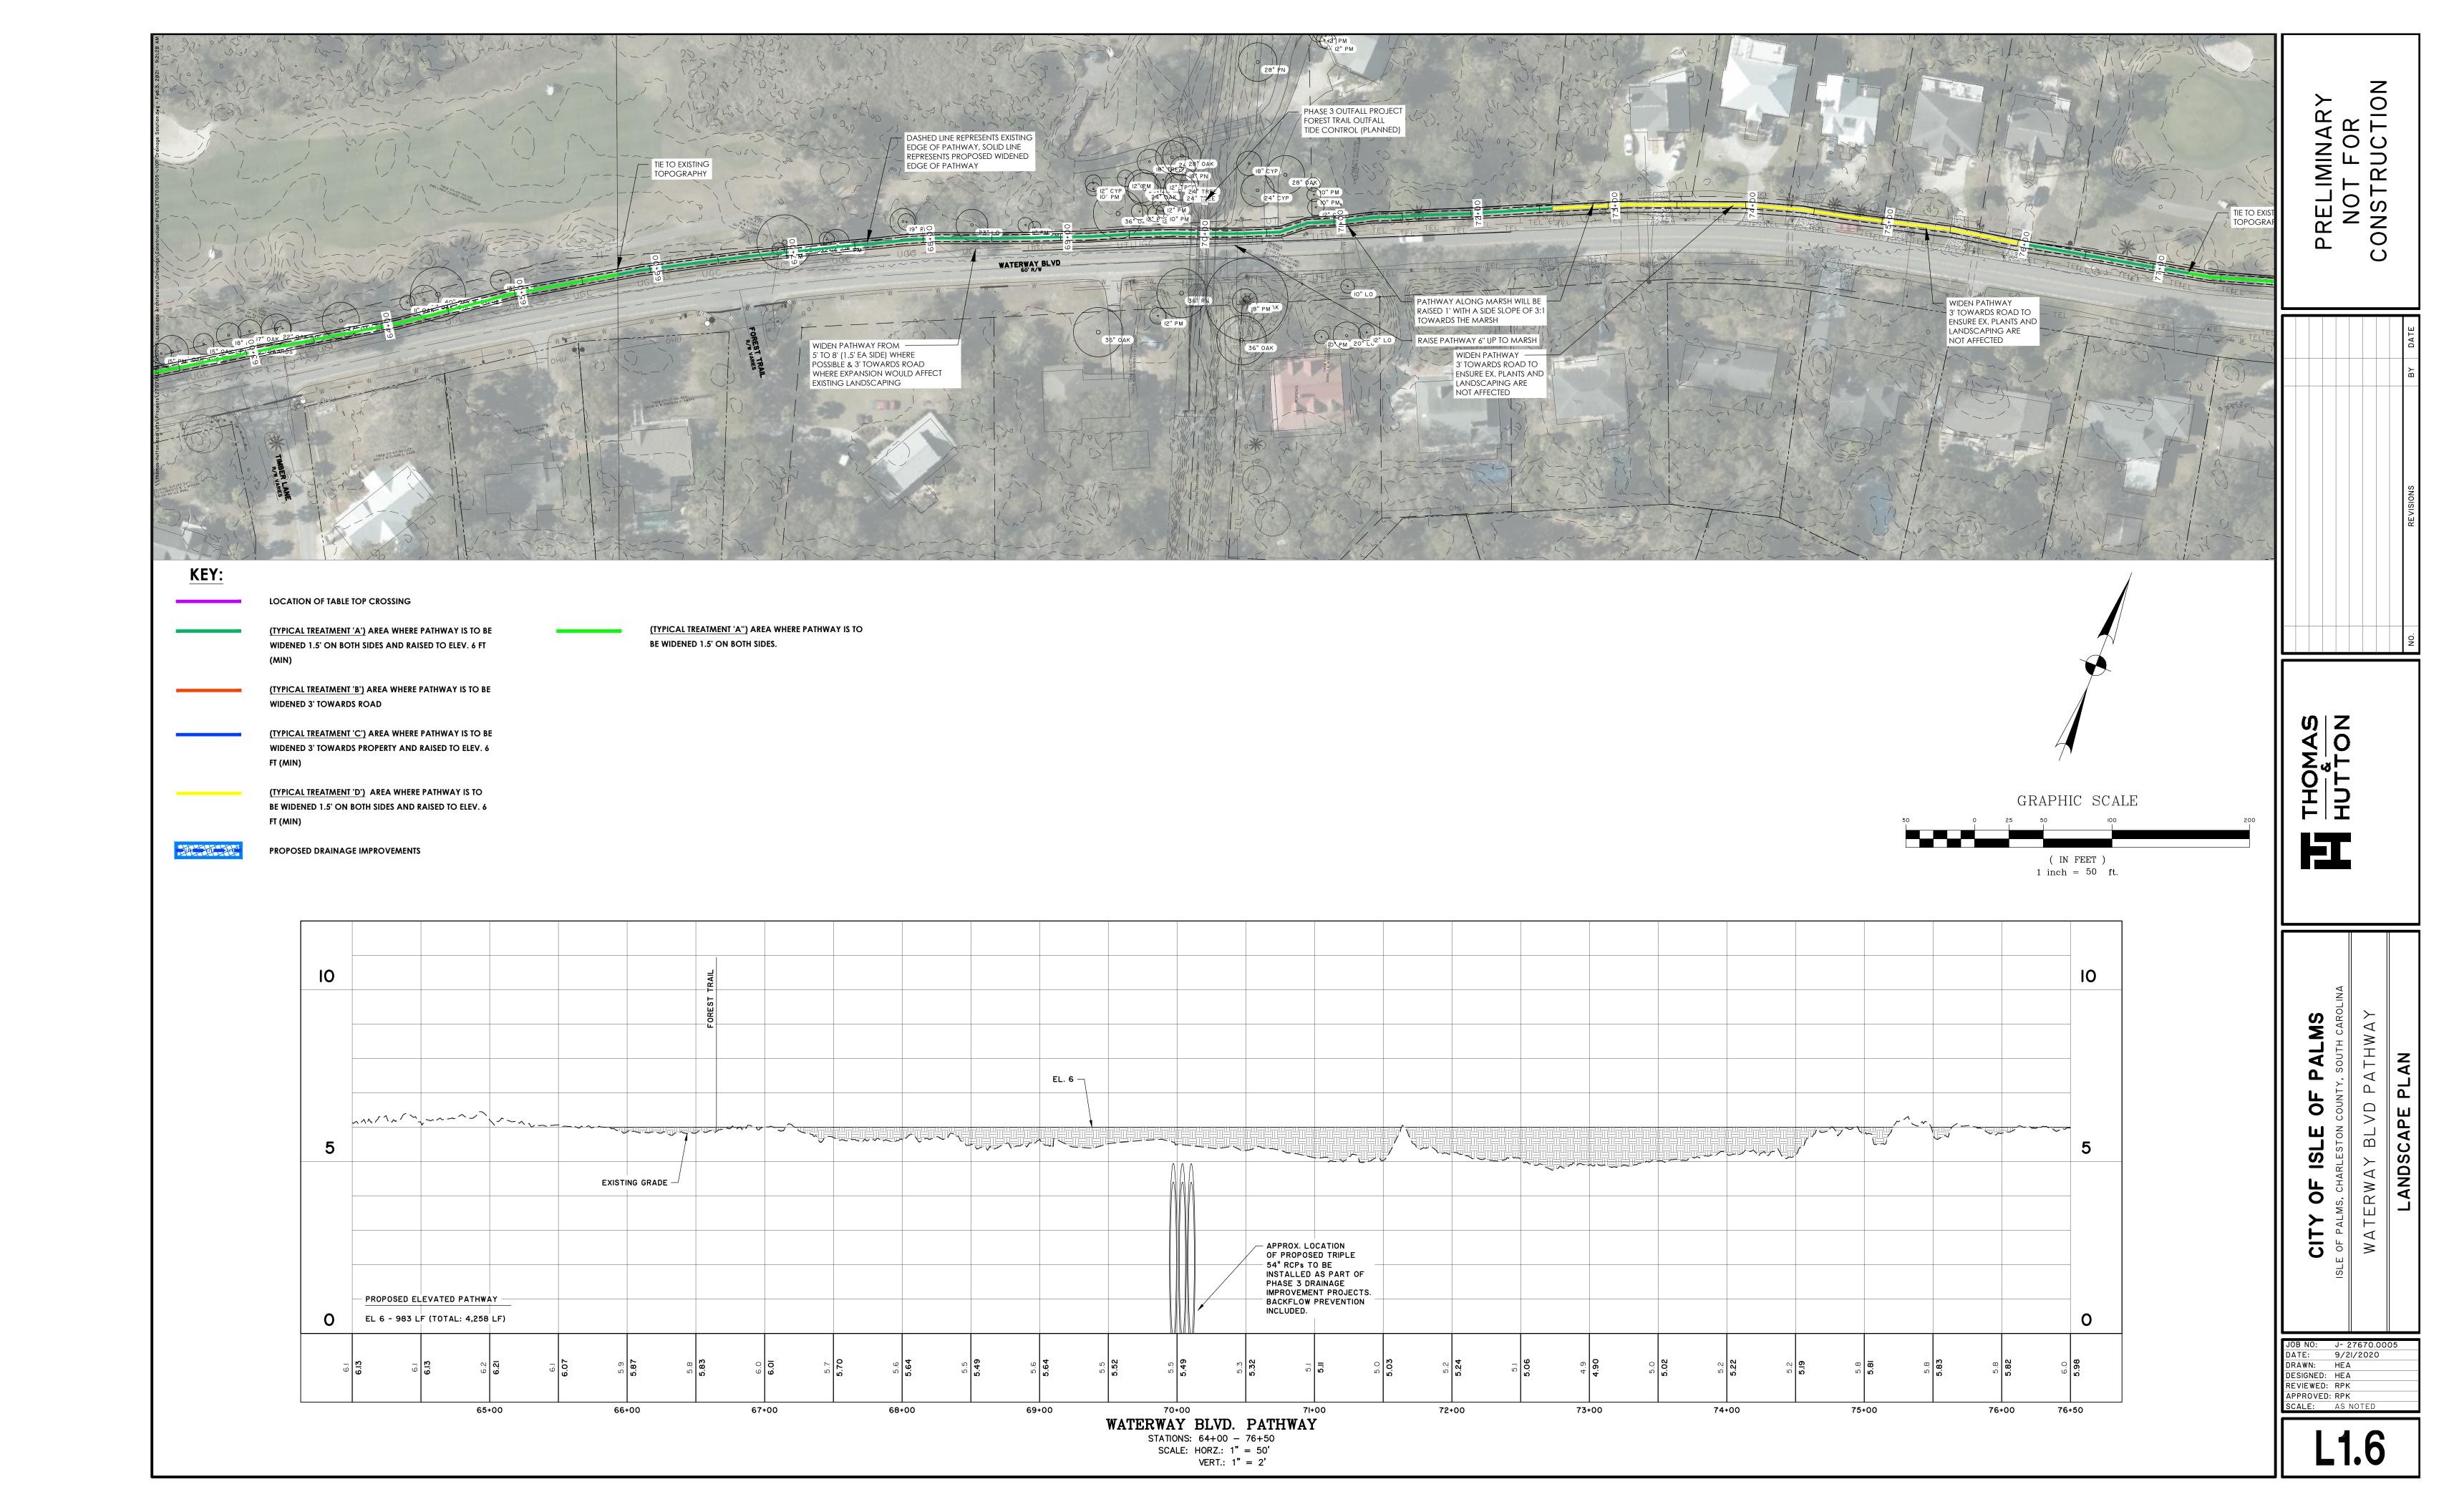

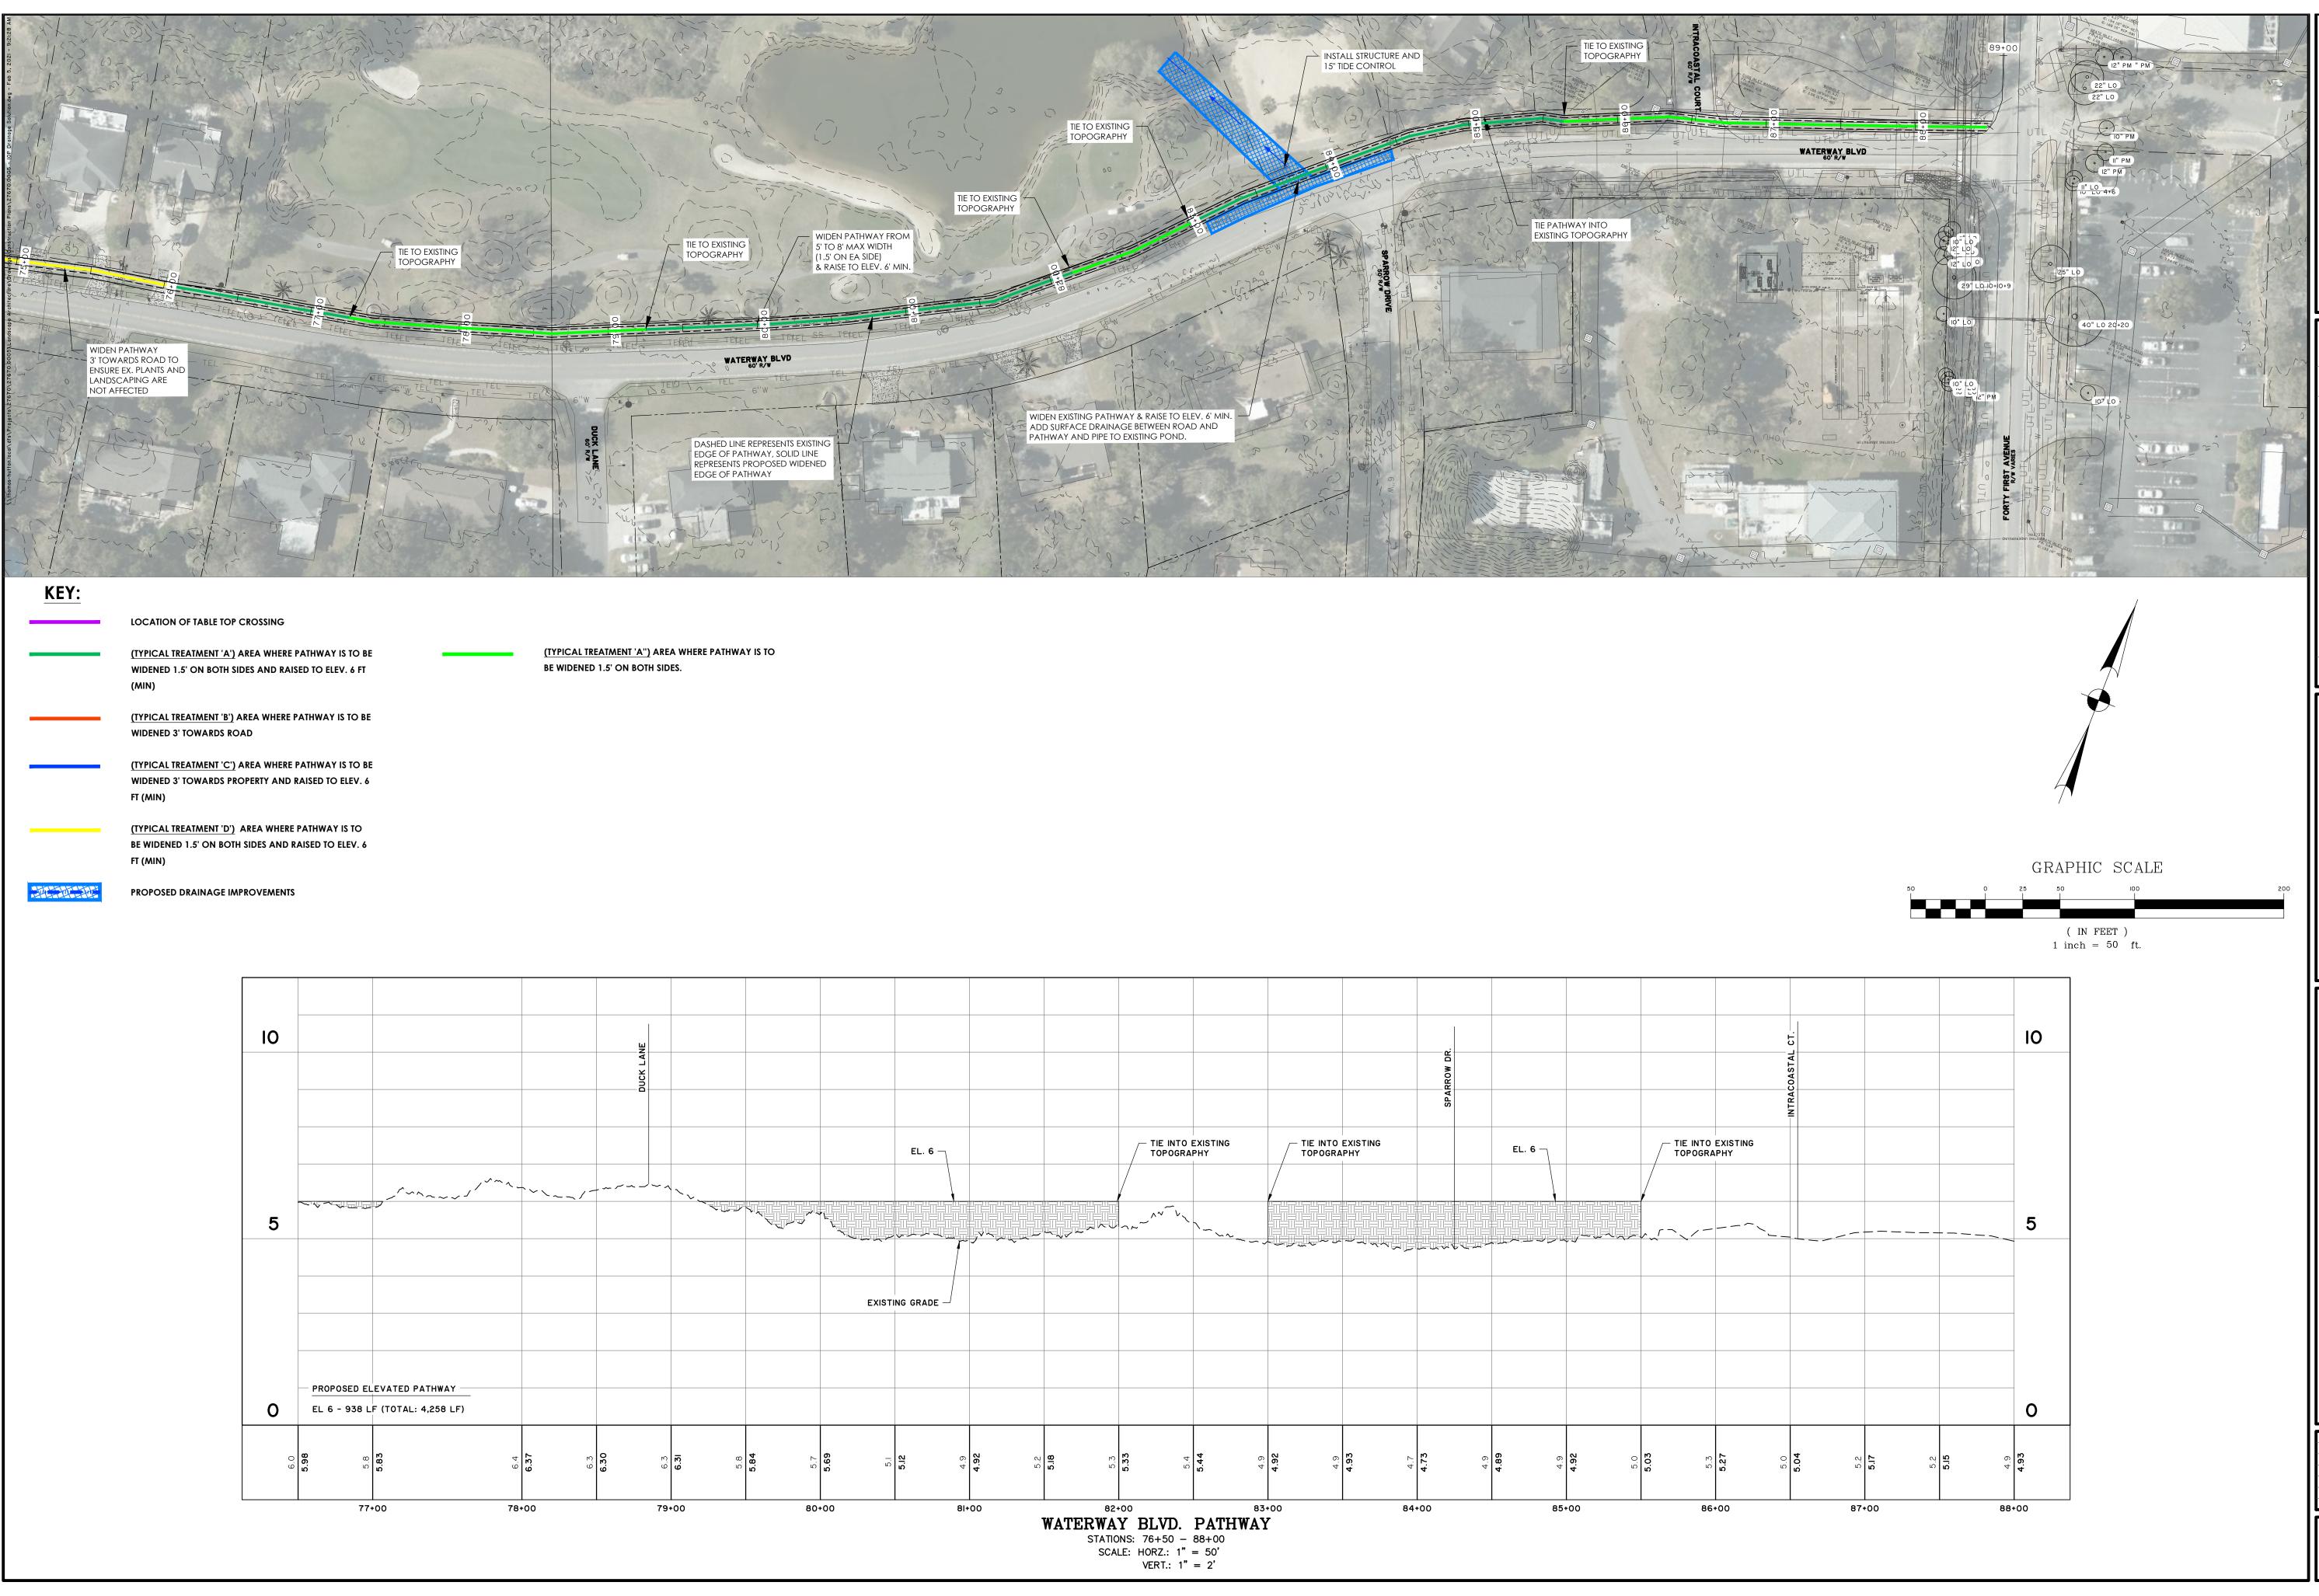
PRELIMINARY NOT FOR CONSTRUCTION

PALMS PATHWAY **PLAN**

OF

OF CITY

DRAWN: HEA
DESIGNED: HEA REVIEWED: RPK APPROVED: RPK SCALE: AS NOTED

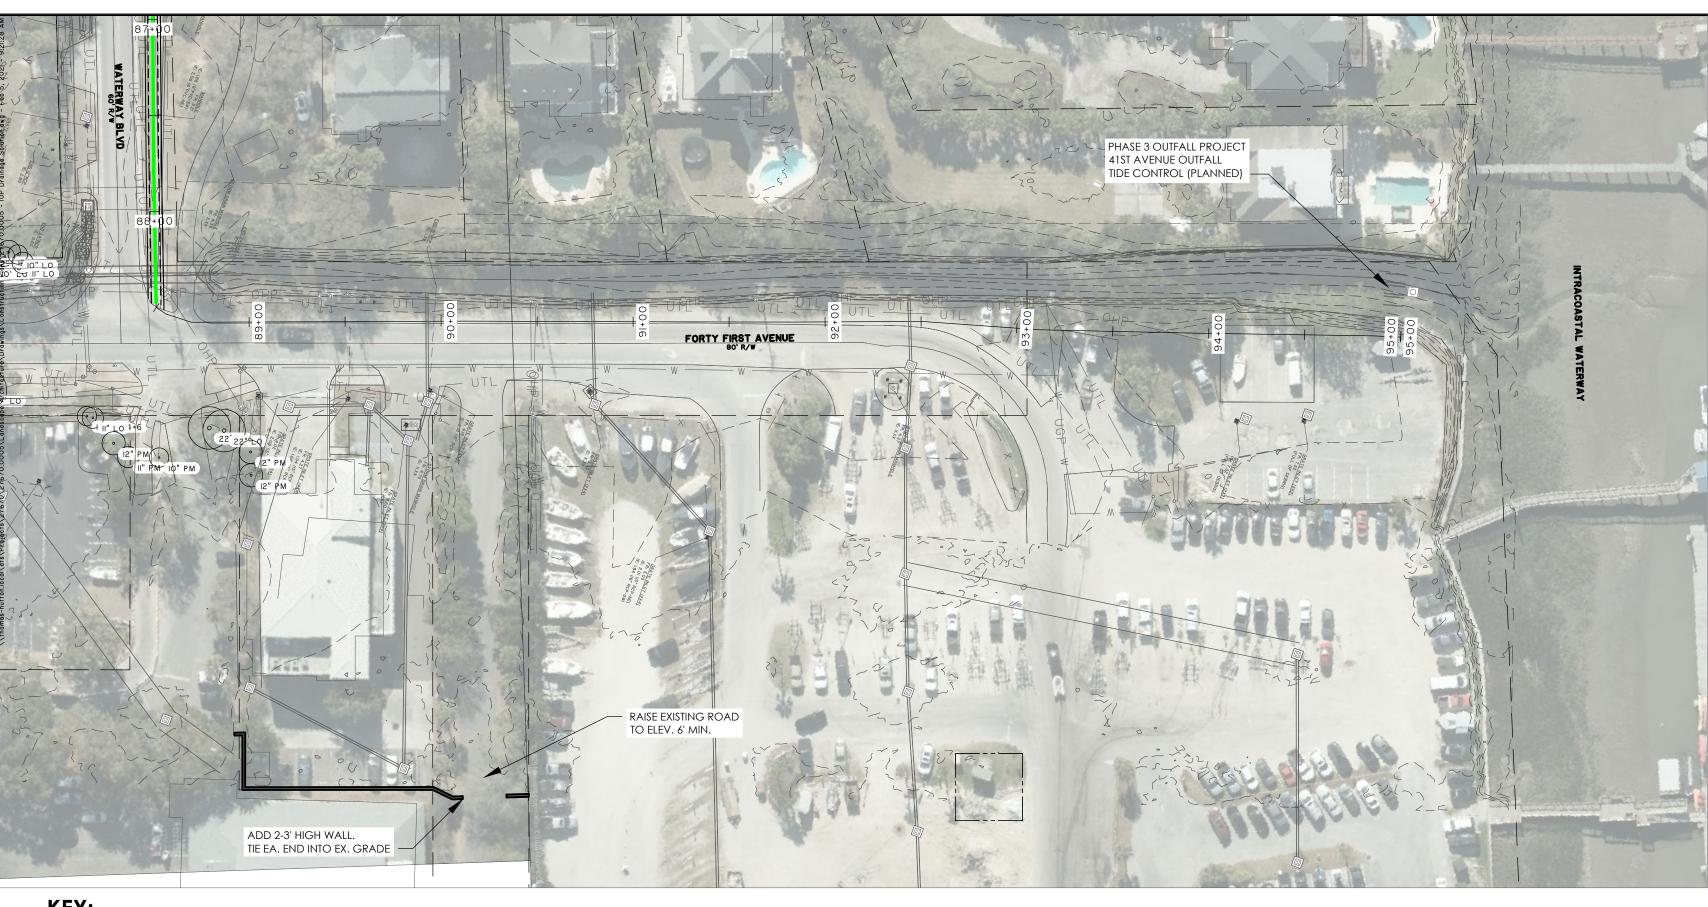

KEY:

LOCATION OF TABLE TOP CROSSING

(TYPICAL TREATMENT 'A') AREA WHERE PATHWAY IS TO BE WIDENED 1.5' ON BOTH SIDES AND RAISED TO ELEV. 6 FT


(TYPICAL TREATMENT 'B') AREA WHERE PATHWAY IS TO BE WIDENED 3' TOWARDS ROAD


> (TYPICAL TREATMENT 'C') AREA WHERE PATHWAY IS TO BE WIDENED 3' TOWARDS PROPERTY AND RAISED TO ELEV. 6

(TYPICAL TREATMENT 'D') AREA WHERE PATHWAY IS TO BE WIDENED 1.5' ON BOTH SIDES AND RAISED TO ELEV. 6


PROPOSED DRAINAGE IMPROVEMENTS

(TYPICAL TREATMENT 'A") AREA WHERE PATHWAY IS TO BE WIDENED 1.5' ON BOTH SIDES.

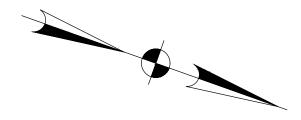

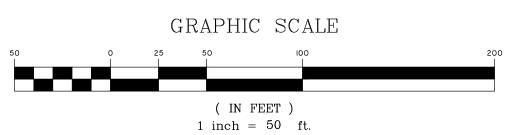

NOT FOR CONSTRUCTION

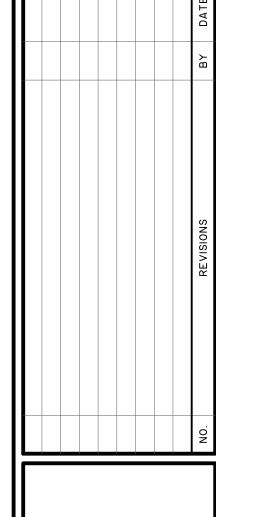

CITY OF ISLE OF PALMS

SLE OF PALMS, CHARLESTON COUNTY, SOUTH CAROLIN

WATERWAY BLVD PATHWAY

LANDSCAPE PLAN

JOB NO: J- 27670.0005


DATE: 9/21/2020

DRAWN: HEA


DESIGNED: HEA

REVIEWED: RPK APPROVED: RPK


SCALE: AS NOTED

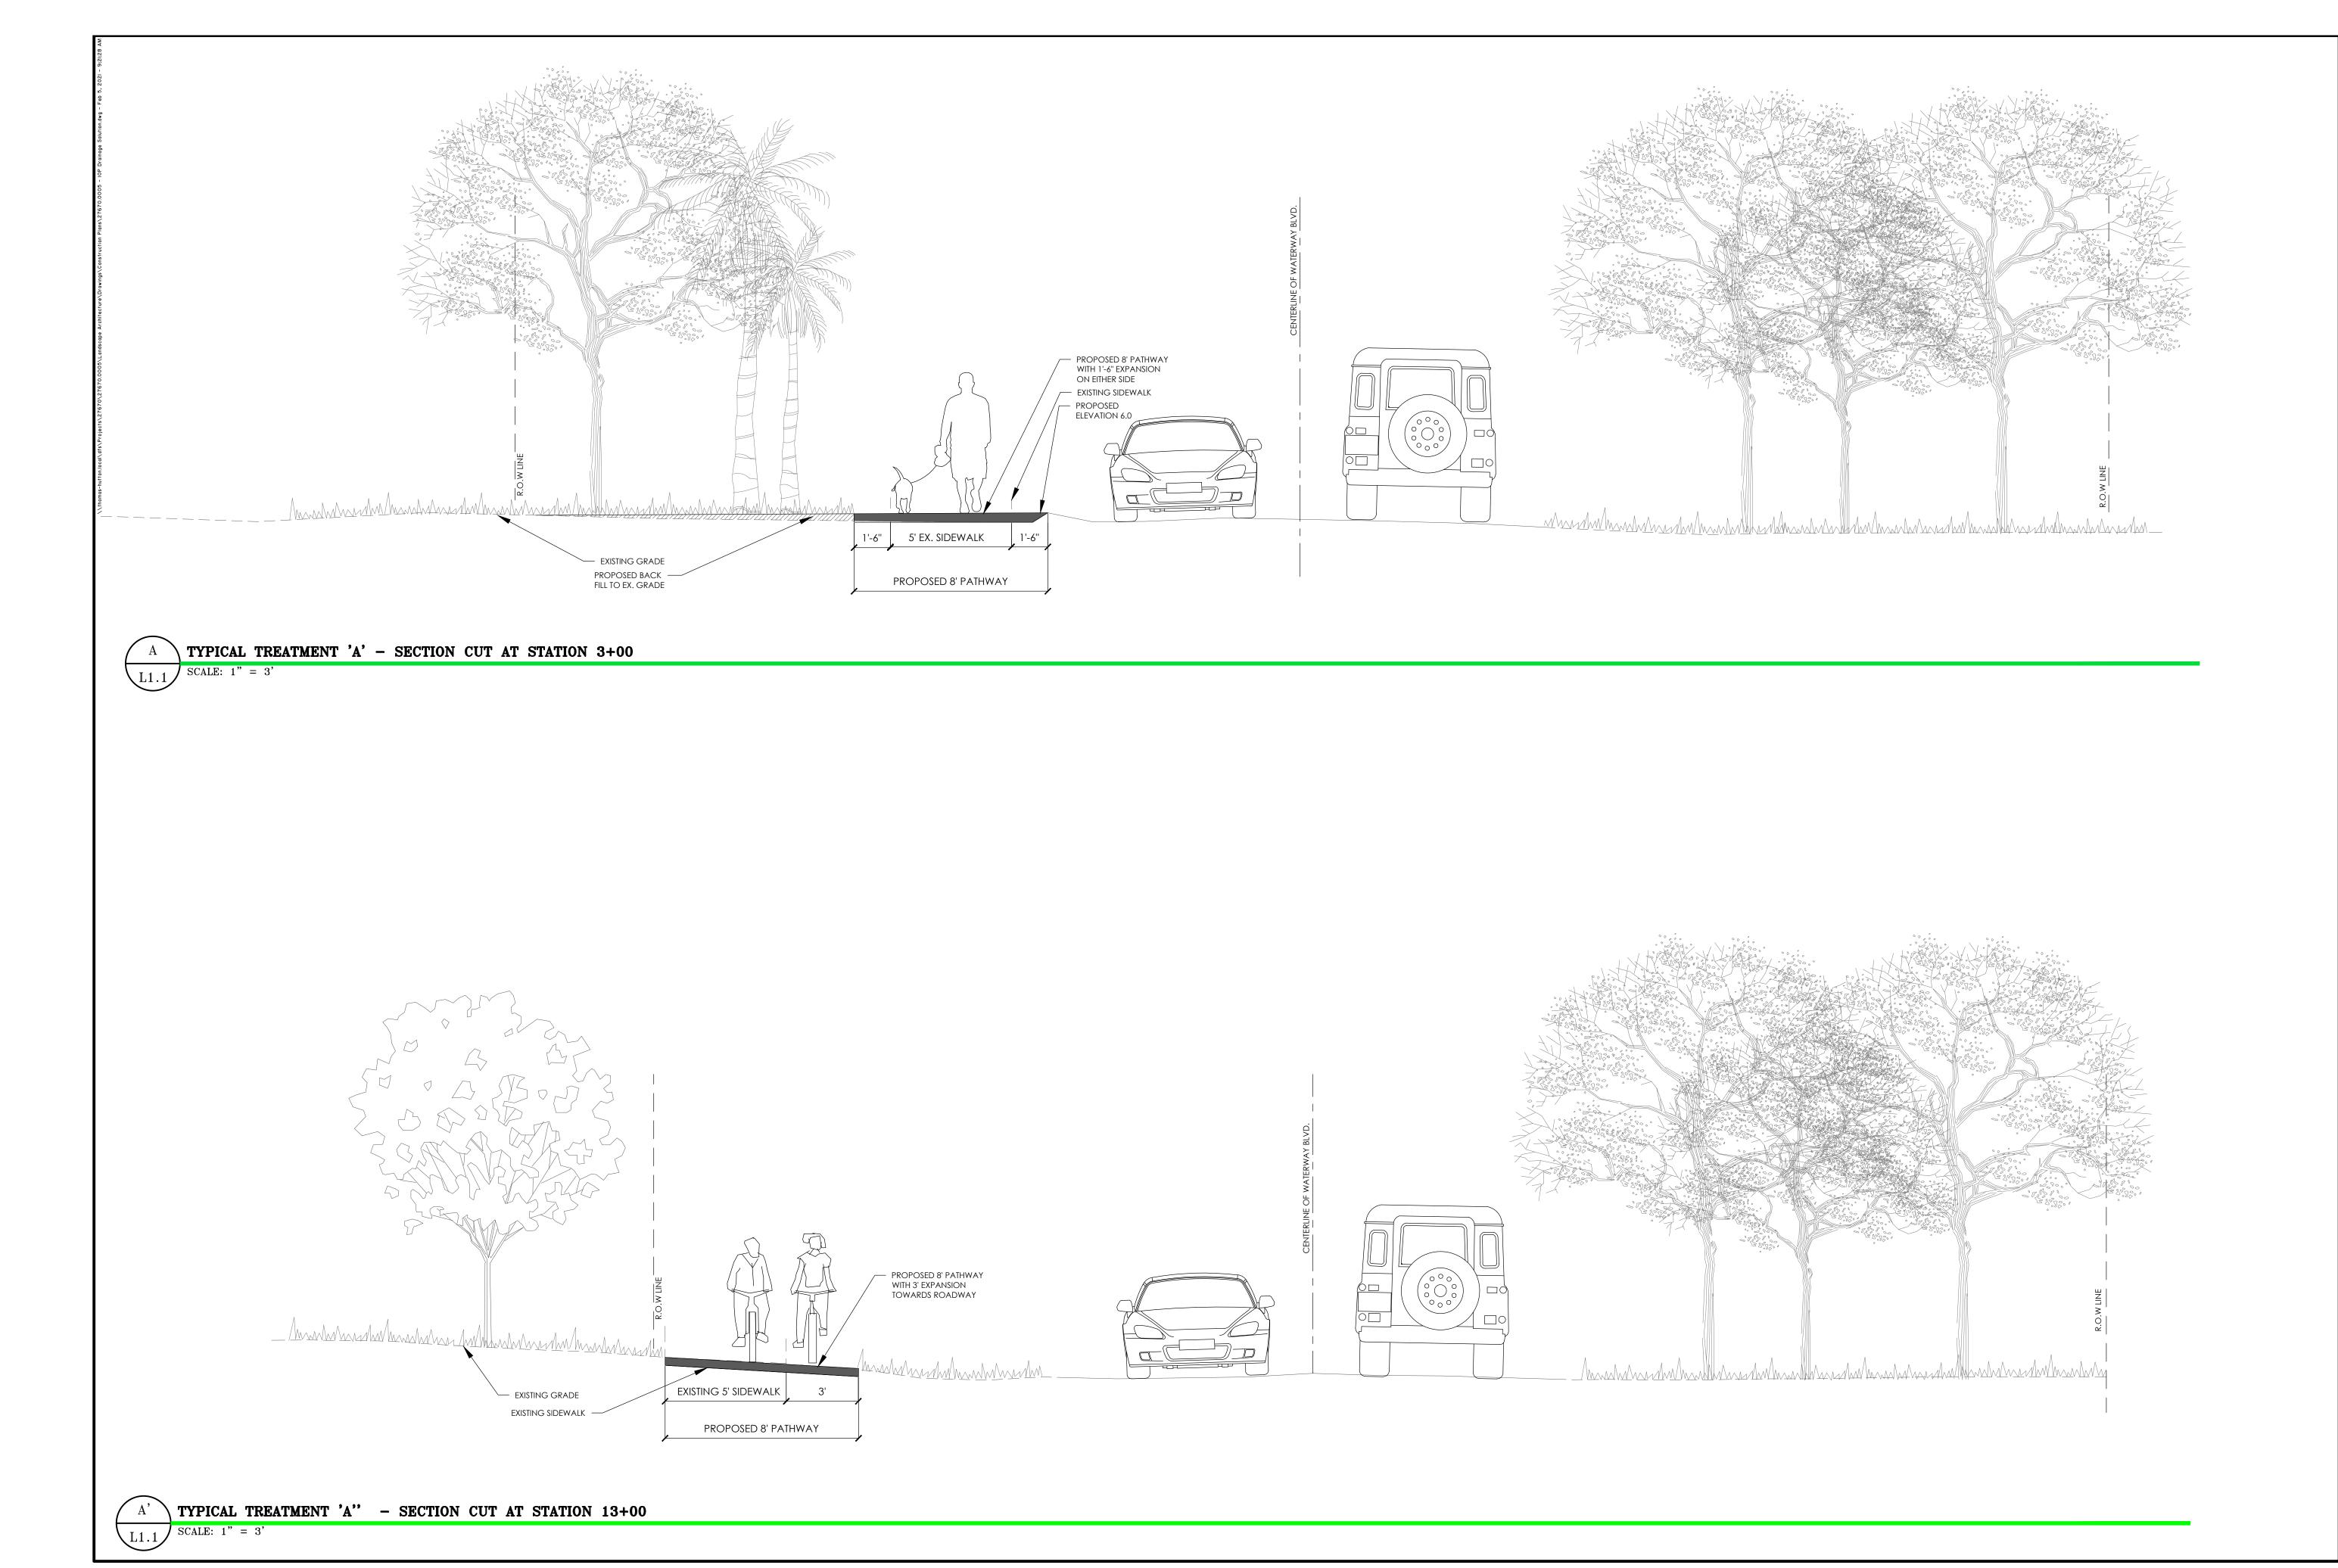

JOB NO: J- 27670.0005
DATE: 9/21/2020
DRAWN: HEA
DESIGNED: HEA
REVIEWED: RPK
APPROVED: RPK
SCALE: AS NOTED

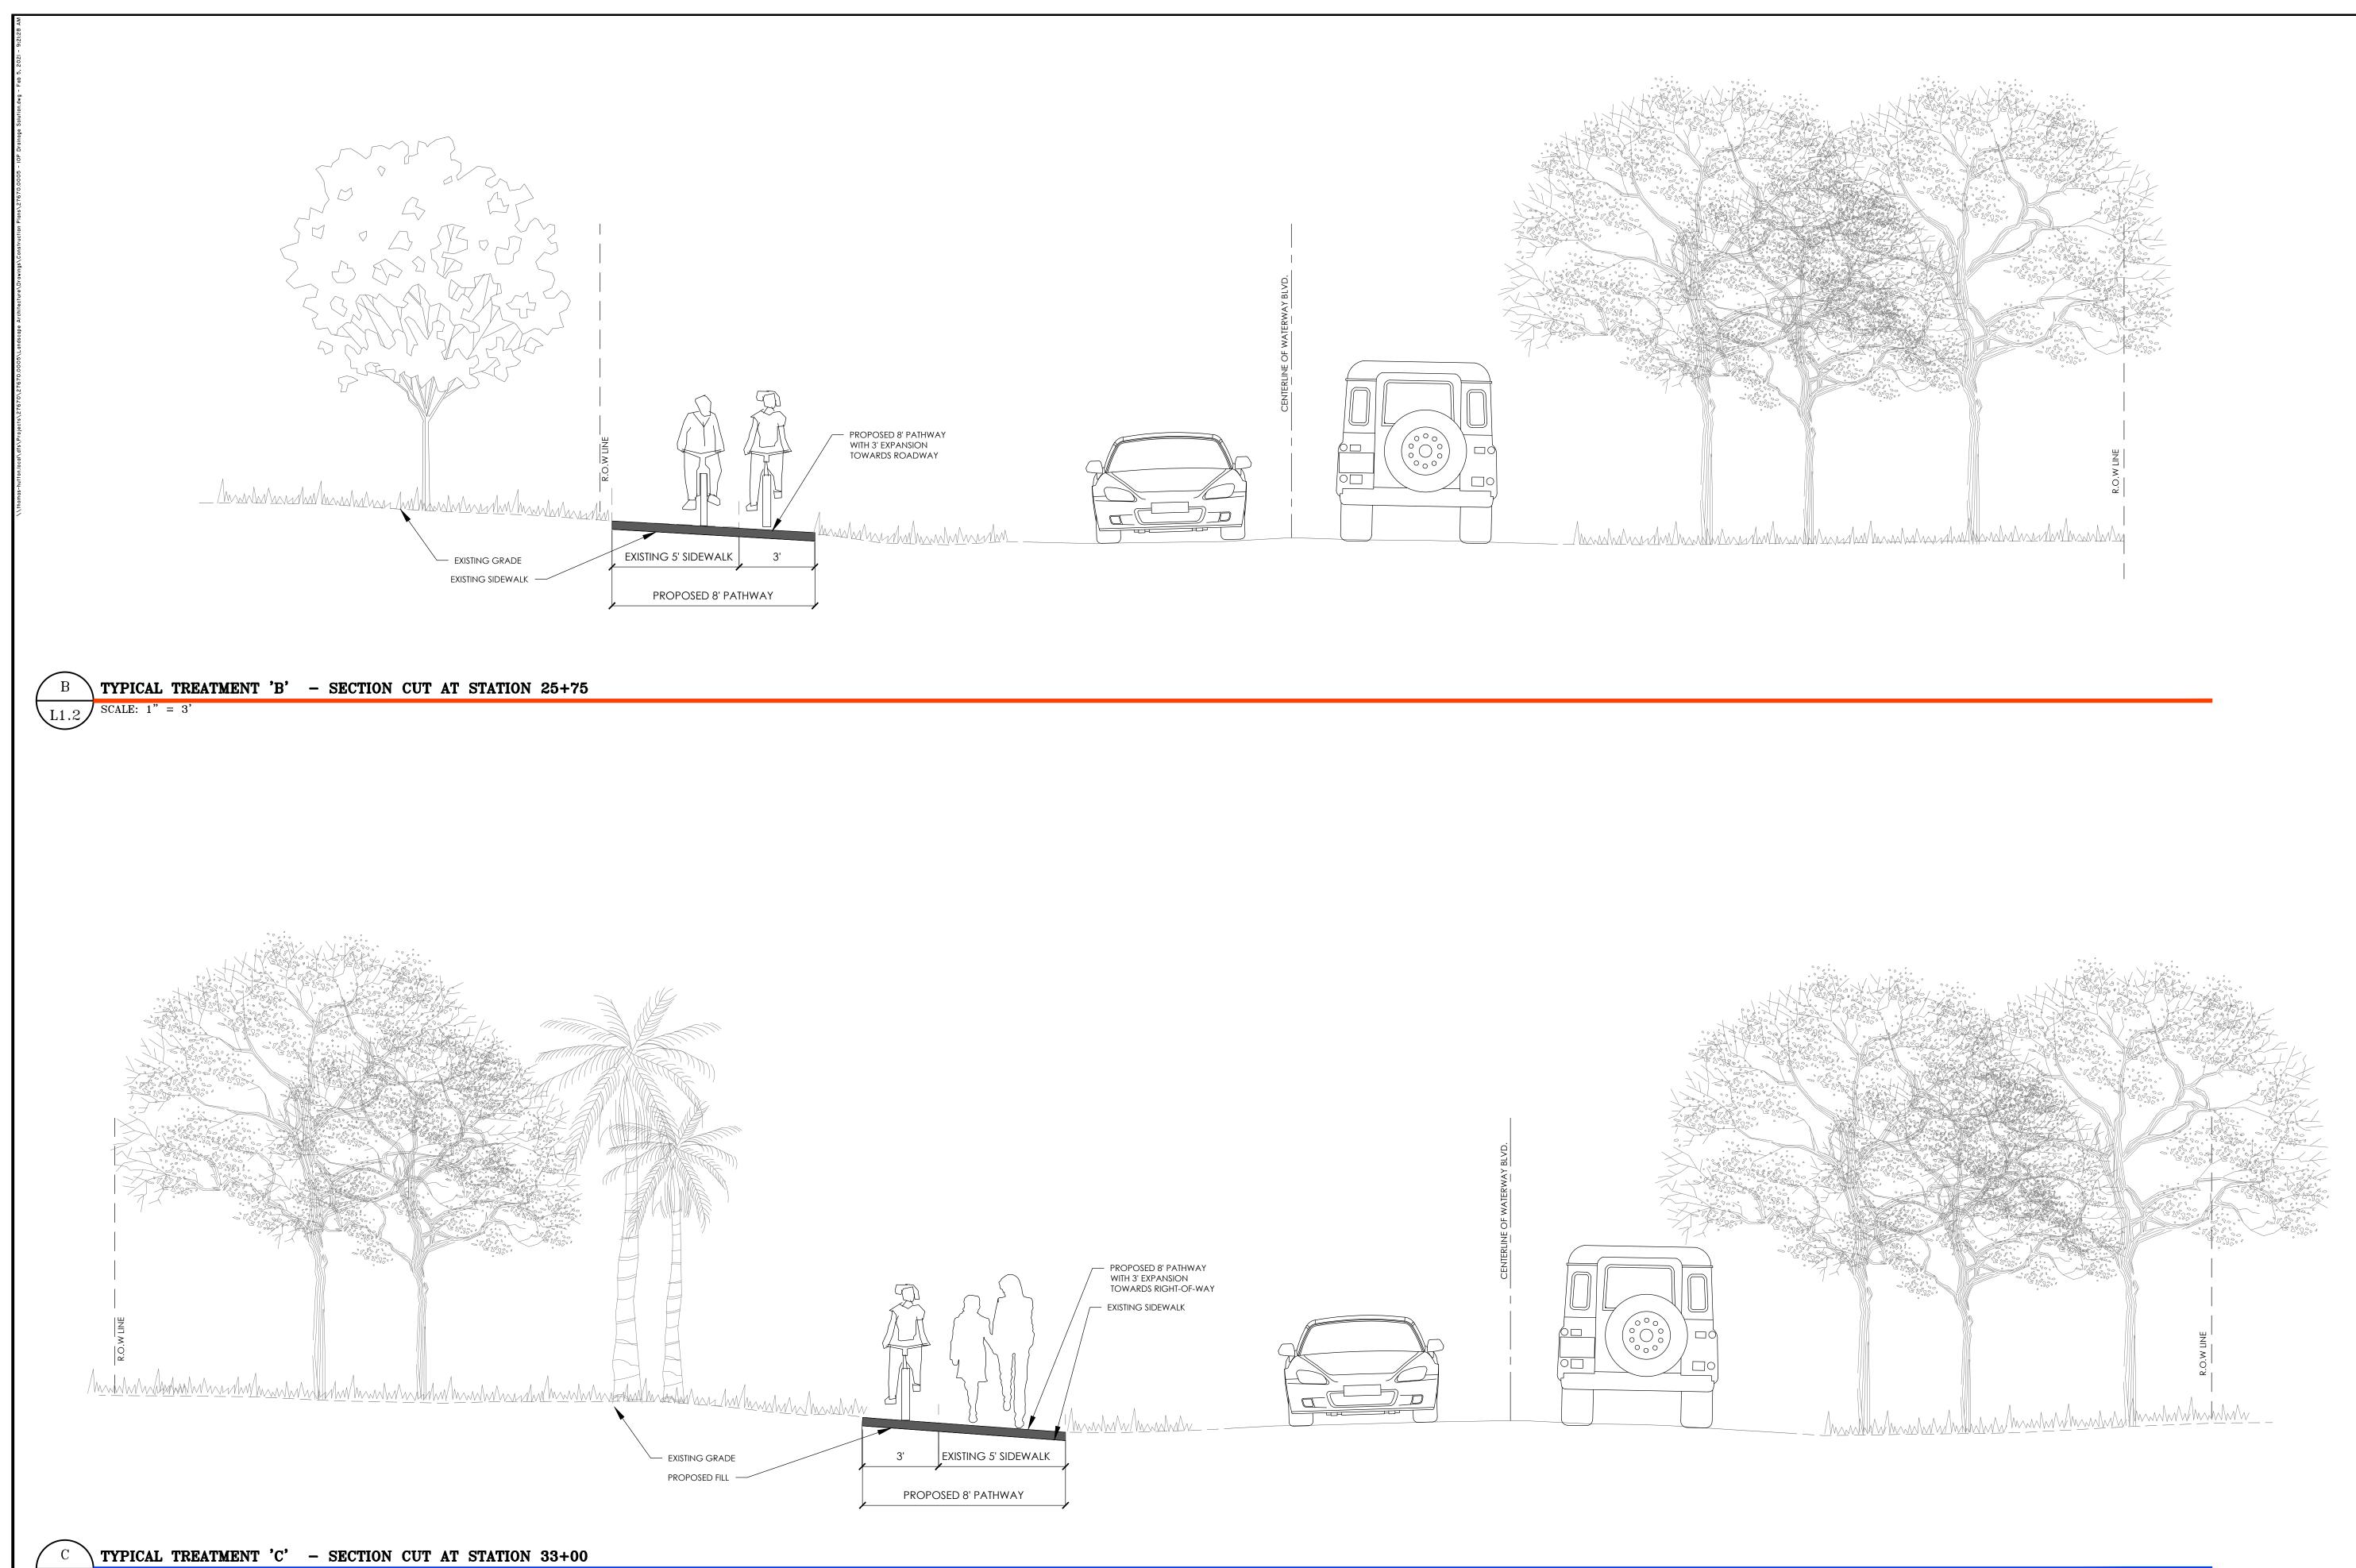

PRELIMINARY NOT FOR ONSTRUCTION

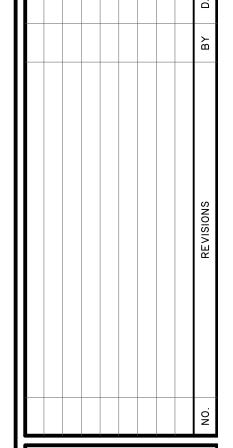


THOMAS HUTTON

3LVD PATHWAY

WATERWAY BLV

JOB NO: J- 27670.0005
DATE: 9/21/2020
DRAWN: HEA
DESIGNED: HEA
REVIEWED: RPK
APPROVED: RPK
SCALE: AS NOTED

L1.10

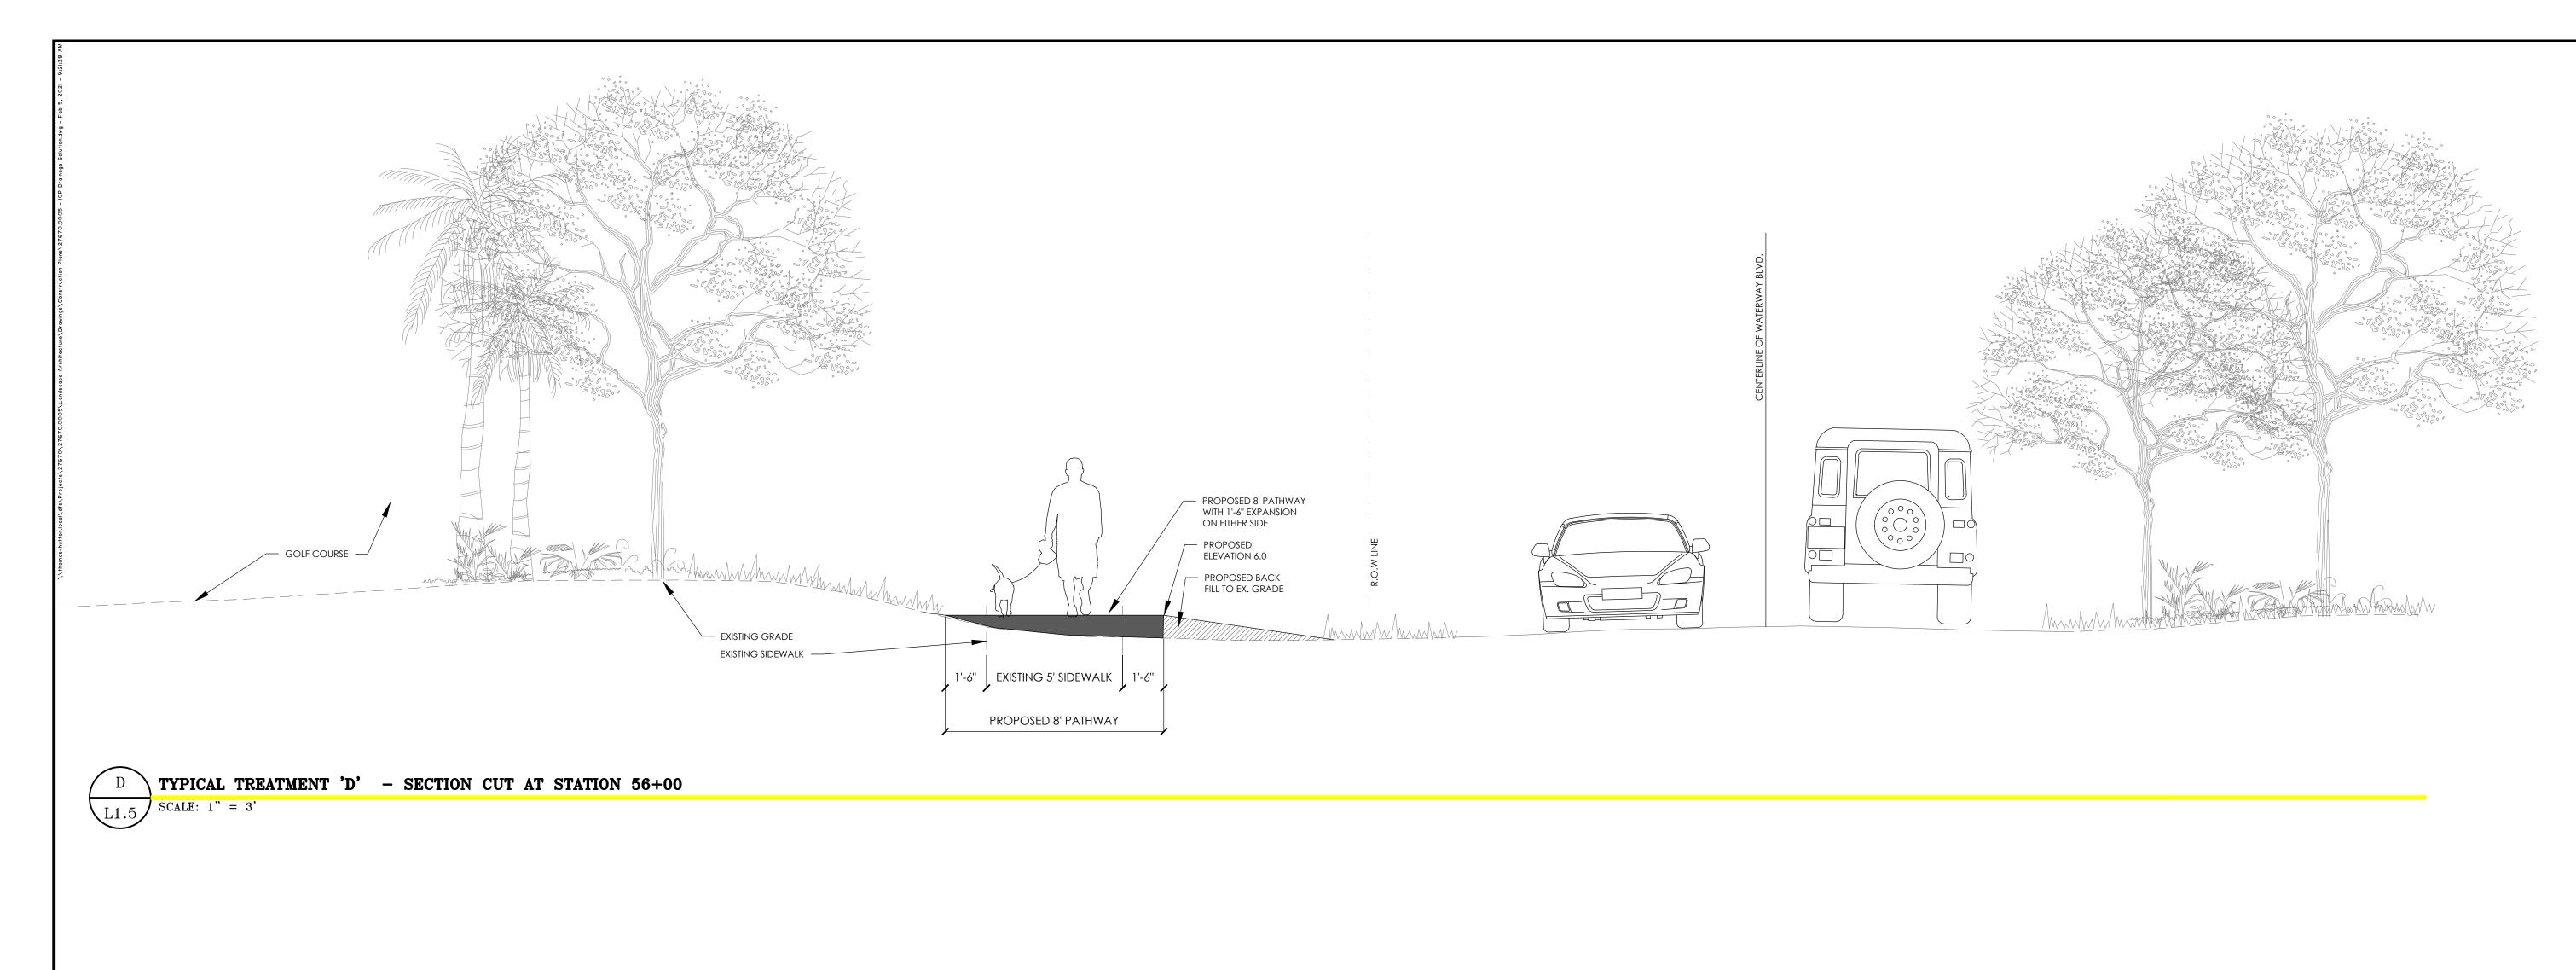

CITY OF ISLE OF PALMS
ISLE OF PALMS, CHARLESTON COUNTY, SOUTH CAROLIN
WATERWAY BLVD PATHWAY
LI.II SECTION ELEVATIONS

JOB NO: J- 27670.0005

DATE: 9/21/2020

DRAWN: HEA

DESIGNED: HEA

REVIEWED: RPK

APPROVED: RPK

SCALE: AS NOTED

PROJECT: Waterway Blvd Pathway

LOCATION: Isle of Palms, SC

ESTIMATOR: BJP

THOMAS & HUTTON

OPINION OF PROBABLE CONSTRUCTION COST					
DATE PREPARED :	DATE PREPARED : 02/23/2021 REVISED:				
	BASIS FOR	RESTIMATE			
Χ	(No design comple	eted-Master Plan)			
	(Preliminary design)				
	(Final design)				
	(Other)				

OPINION OF PROBABLE CONSTRUCTION COST

Since the Engineer has no control over the cost of labor, materials, equipment, over the Contractor's methods of determining prices, or over competitive bidding or market conditions, the Opinions of Probable Construction Costs provided for herein are made on the basis of his experience and qualifications. These opinions represent his best judgment as a design professional familiar with the construction industry. However, the Engineer cannot and does not guarantee that proposals, bids, or the construction cost will not vary from Opinions of Probable Construction Costs prepared by him.

		QUA	NTITY	CC	OST
ITEM	DESCRIPTION	UNITS	UNIT MEASURE	PER UNIT	TOTAL COST
7141113	18" RC pipe (Class III)	920	LF	\$ 75.00	\$ 69,000.00
	Grate Inlet (48" X48")	9	EA	\$ 4,500.00	\$ 40,500.00
	15" Tide Control Check Valve	5	EA	\$ 3,500.00	\$ 17,500.00
	18" Tide Control Check Valve	4	EA	\$ 3,500.00	\$ 14,000.00
7192020	Drop Inlet (24" x 36")	6	EA	\$ 4,500.00	\$ 27,000.00
	Typical Treatment A	2,250	LF	\$ 73.00	\$ 164,250.00
	Typical Treatment A (driveways)	200	LF	\$ 200.00	\$ 40,000.00
	Typical Treatment A'	3,720	LF	\$ 19.00	\$ 70,680.00
	Typical Treatment B	1,825	LF	\$ 19.00	\$ 34,675.00
	Typical Treatment C	385	LF	\$ 19.00	\$ 7,315.00
	Typical Treatment D	345	LF	\$ 19.00	\$ 6,555.00
	Table Top Crossing	35	LF	\$ 37.00	\$ 1,295.00
				SUBTOTAL	
	Contingency at	25.0	%		\$ 123,192.75
	GRAND TOTAL OPINION OF CONSTRUCTION COST				\$615,963

Notes:

- 1. No property costs (drainage easement, temporary const. easements, right-of way, etc.) are included.
- 2. Does not include mobilization, traffic control, construction staking, as-built construction plans, silt fence, etc.
- 3. No soft costs included such as Engineering, Surveying, Permitting, Legal, Land Acquisition, etc.

TREATMENT	DESCRIPTION	LF x WIDTH	UNIT MEASURE	IN COST UNITS	UNIT MEASURE	PER UNIT	TOTAL COST	COST PER LE	TOTAL COS	
		07000	0.5	0.40		#15 000 00	A 0 007 F0	T	1	
	Selected Clearing & Grubbing (12' x 1')	27000	SF	0.62	AC	\$15,000.00	\$ 9,297.52			
	Removal & Disposal of Existing Pavement (Pathway) (5' x 1')	11250	SF	1249.88	SY	\$ 75.00	\$93,740.63			
Typical Treatment A	Marine Limestone Base Course (4" Uniform) (3' x 1')	6750	SF	749.99	SY	\$ 15.00	\$11,249.89		\$ 73.0	
,,,,,,,,,,,,,,,,,,,,,,,,,,,,,,,,,,,,,,,	Surface Plane Asphalt Pavement 1.0" (8' x 1') + (3' x 1')	24750	SF	2749.97	SY	\$ 5.00	\$13,749.86	1	7	
	Controlled Fill - Borrow Material (12' x 1' x 0.5')	13500	CF	500.00	CY	\$ 30.00	\$14,999.99			
	Sodding (4' x 1')	9000	SF	999.90	SY	\$ 15.00	\$14,998.50	\$ 7.00		
	Selected Clearing & Grubbing (12' x 1')	2400	SF	0.06	AC	\$15,000.00	\$ 826.45	\$ 5.00		
	Removal & Disposal of Existing Pavement (Pathway) (5' x 1')	1000	SF	111.10	SY	\$ 75.00	\$ 826.45 \$ 8.332.50	\$ 42.00		
	Marine Limestone Base Course (4" Uniform) (3' x 1')	600	SF	66.67	SY	\$ 75.00	\$ 999.99	\$ 42.00		
Typical Treatment A (driveways)	Surface Plane Asphalt Pavement 1.0" (8' x 1') + (3' x 1')	2200	SF	244.44	SY	\$ 5.00	\$ 1,222.21	\$ 7.00	\$ 200.0	
	Controlled Fill - Borrow Material (12' x 1' x 0.5')	1200	CF	44.44	CY	\$ 30.00	\$ 1,333.33	1		
	Replacement of Existing Driveways (12' x 1')	2400	SF	266.64	SY	\$ 100.00	\$26,664.00			
	Replacement of Existing Diveways (12 x 1)	2400	J 31	200.04	31	ψ 100.00	Ψ20,004.00	ψ 104.00		
	Selected Clearing & Grubbing (5' x 1')	18600	SF	0.43	AC	\$15,000.00	\$ 6,404.96	\$ 2.00		
	Marine Limestone Base Course (4" Uniform) (3' x 1')	11160	SF	1239.99	SY	\$ 15.00	\$18,599.81	\$ 5.00		
Typical Treatment A'	Surface Plane Asphalt Pavement 1.0" (8' x 1') + (3' x 1')	40920	SF	4546.62	SY	\$ 5.00	\$22,733.11	\$ 7.00	\$ 19.0	
	Sodding (3' x 1')	11160	SF	1239.88	SY	\$ 15.00	\$18,598.14	\$ 5.00	1	
	•									
	Selected Clearing & Grubbing (5' x 1')	9125	SF	0.21	AC	\$15,000.00	\$ 3,142.22			
Typical Treatment B	Marine Limestone Base Course (4" Uniform) (3' x 1')	5475	SF	608.33	SY	\$ 15.00	\$ 9,124.91	\$ 5.00	\$ 19.0	
Typical freament b	Surface Plane Asphalt Pavement 1.0" (8' x 1') + (3' x 1')	20075	SF	2230.53	SY		\$11,152.67	\$ 7.00	φ 17.0°	
	Sodding (3' x 1')	5475	SF	608.27	SY	\$ 15.00	\$ 9,124.09	\$ 5.00		
	Selected Clearing & Grubbing (5' x 1')	1925	SF	0.04	AC	\$15,000.00	\$ 662.88	\$ 2.00	1	
	Marine Limestone Base Course (4" Uniform) (3' x 1')	1155	SF	128.33	SY	\$ 15.00	\$ 662.88 \$ 1.924.98			
Typical Treatment C	Surface Plane Asphalt Pavement 1.0" (8' x 1') + (3' x 1')	4235	SF	470.55	SY	1	\$ 2,352.75	1	\$ 19.0	
	Sodding (3' x 1')	1155	SF	128.32	SY	\$ 15.00	\$ 1,924.81	\$ 7.00		
	Jodding (5 x 1)	1133	31	120.52	31	ф 15.00	φ 1,724.01	\$ 5.00		
	Selected Clearing & Grubbing (5' x 1')	1725	SF	0.04	AC	\$15,000.00	\$ 594.01	\$ 2.00		
	Marine Limestone Base Course (4" Uniform) (3' x 1')	1035	SF	115.00	SY	\$ 15.00	\$ 1,724.98			
Typical Treatment D	Surface Plane Asphalt Pavement 1.0" (8' x 1') + (3' x 1')	3795	SF	421.66	SY	\$ 5.00	\$ 2,108.31	\$ 7.00	\$ 19.0	
	Sodding (3'x 1')	1035	SF	114.99	SY	\$ 15.00	\$ 1,724.83	\$ 5.00		
					1	ı ·		1 -	1	
Table Ten Cressing	Hot Mix Asphalt Surface Course Type B (9.5' x 1' x 0.5')*	166.25	CF	9.14	TON	\$ 100.00	\$ 914.38	\$ 27.00	\$ 37.0	
Table Top Crossing	Crosswalk Striping	-	-	35.00	LF	\$ 10.00	\$ 350.00	\$ 10.00	\$ 37.0	

*(9.5' x 1' x 0.5') assuming 8' flat top with 3:1 side slopes and 6" layer thickness

682 JOHNNIE DODDS BOULEVARD, SUITE 100 | POST OFFICE BOX 1522 MT. PLEASANT, SC 29464 | 843.849.0200 WWW.THOMASANDHUTTON.COM

April 9, 2021

Mr. Douglas Kerr City of Isle of Palms P.O. Drawer 508 Isle of Palms, SC 29451

Re: Phase 3 Drainage Outfall

Design and Permitting

City of Isle of Palms, South Carolina

T&H J-27670.0004

Change Order Request

Dear Mr. Kerr:

Thank you for requesting our professional engineering services for the Isle of Palms Phase 3 Drainage Outfalls Project. As you are aware, Thomas & Hutton has completed the design of the three outfalls and is currently in the permitting phase. Each outfall is being permitted separately for scheduling purposes, with the following prioritization: 1) Forest Trail Outfall, 2) 30th Avenue Outfall, and 3) 41st Avenue Outfall. This includes separate permits, for each outfall, including SCDHEC-OCRM (CZC), SCDHEC-BOW (NPDES), Charleston County MS4, and SCDOT. In addition, two of the three outfalls have two (2) Critical Area permits (USACE/OCRM) associated with them, for a total of five (5) Critical Area permits. This is due to the impact threshold and mitigation requirements. The current permitting approach will minimize the need for mitigation.

Now that designs are completed and permitting is underway, it is apparent that some mitigation will be required. Our sub-consultant, Terracon, is proposing to provide services for the Permittee-responsible Mitigation Coordination and Plan.

Funding assistance has been provided in the form of identifying funding sources, attending meetings, and developing an application package for an RIA Grant for the entire Phase 3 area. Based on feedback from the grant authority from the Phase 3 application, the grant application package was revised to be specific to the Forest Trail Outfall Project. We expect to continue to provide support and coordination on the current application, and with future applications. We expect to apply for an additional grant for the 41st Avenue Outfall Project once the grant cycle reopens.

Given the required approach to break out the outfalls into separate permits, the need for a mitigation plan and coordination, and the grant application services provided to date and expected to be provided in the future, we are requesting the current contract be amended to increase the budgets for the Permitting Task and Funding Assistance Task.

SCOPE OF SERVICES

The proposed Scope of Services includes:

Mr. Douglas Kerr City of Isle of Palms Change Order Request April 9, 2021 Page 2

Forest Trail Outfall

- Infrastructure Critical Area Permit Submittal & Coordination Submitted, coordination is ongoing.
- Channel Critical Area Permit Submittal & Coordination Submitted, coordination is ongoing.
- SCDOT Encroachment Permit Submitted, addressed comments, and resubmitted.
- Charleston County MS4 Submitted
- SCDHEC-OCRM (CZC) Conditional Approval
- SCDHEC-BOW (NPDES) Submitted

30th Avenue Outfall

- Infrastructure Critical Area Permit Submittal & Coordination Submitted, coordination is ongoing.
- Channel Critical Area Permit Submittal & Coordination Submitted, coordination is ongoing.
- SCDOT Encroachment Permit Submitted, in process of addressing comments.
- Charleston County MS4 Application completed.
- SCDHEC-OCRM (CZC) Application completed.
- SCDHEC-BOW (NPDES) Application completed.

41st Avenue Outfall

- Critical Area Permit Submittal & Coordination Application is in process.
- SCDOT Encroachment Permit Submitted, in process of addressing comments.
- Charleston County MS4 Application completed.
- SCDHEC-OCRM (CZC) Application completed.
- SCDHEC-BOW (NPDES) Application completed.

Permittee-responsible Mitigation Coordination and Plan

Funding Assistance

- Coordination and support for Forest Trail Outfall RIA Grant
- Development of permit package, coordination, and support for 41st Avenue RIA Grant – Next Grant Cycle

SCHEDULE

We will provide the proposed services by mutual agreement with the City. We understand that these projects are time sensitive, and we will execute the services in a timely manner.

CONTRACT TERMS

This change order is to be performed under the terms and conditions of our original contract with the City (Phase 3 Drainage Outfall Design and Permitting Contract, January 16, 2019).

This proposed change order will be open for acceptance until April 30, 2021 unless changed by us in writing. The Consultant has developed this change order based on our anticipated 2021 rates. We have assumed (as most services are provided on a time and

Mr. Douglas Kerr City of Isle of Palms Change Order Request April 9, 2021 Page 3

expense basis) that labor rates will be adjusted each calendar year. We appreciate the opportunity to prepare this proposal and look forward to working with you on the project.

COMPENSATION

Phase	Fee	Current	Additional	Revised
	Structure	Budget	Fee	Budget
Permitting Phase	Time & Expense	\$66,200.00	\$37,000.00	\$103,200.00
Funding Assistance	Time & Expense	\$12,900	\$6,300	\$19,200

Should you have any questions about this contract change request, please do not hesitate to contact me at (843) 725-5280, or via e-mail at karkowski.r@tandh.com.

Sincerely,

THOMAS & HUTTON

Richard Karkowski, PE, PH, CPSWQ, D.WRE

Principal / Project Manager

RPK/ala

Enclosures: 1. 2021 Rate Sheet

THOMAS & HUTTON

Consulting Services on a Time and Expense Basis

January 1, 2021

Thomas & Hutton provides services on a time and expense basis as follows:

- 1. This basis includes allowance for direct salary expenses and for direct non-salary expenses. It also provides for services we may subcontract to others.
- 2. Direct salary expenses are generally based upon our payroll costs. The payroll costs include the cost of salaries and wages (including sick leave, vacation, and holiday pay) for time directly chargeable to the project; plus, unemployment, excise, payroll taxes, and contributions for social security, employment compensation insurance, retirement benefits, and medical and insurance benefits.

The current hourly rate charges for each skill position for 2021 are as follows:

Hourly Rate	Engineer	Survey	Landscape	GIS	Quality Control	Business/ Administrative
\$ 250.00	Consultant	Consultant	Consultant	Consultant	Consultant	
\$ 225.00	Senior Manager	Senior Manager	Senior Manager	Senior Manager	Senior Manager	Senior Manager
\$ 205.00	Project Manager V Project Engineer V	Survey Manager V Project Surveyor V Survey Party (3–Men)	Landscape Architect V LA Project Manager V	GIS Manager V		
\$ 190.00	Project Manager IV Project Engineer IV	Survey Manager IV Project Surveyor IV	Landscape Architect IV LA Project Manager IV	GIS Manager IV		Senior Application Developer IV, Software/Computer Consultant IV
\$ 175.00	Project Manager III Project Engineer III	Survey Manager III Project Surveyor III	Landscape Architect III LA Project Manager III	GIS Manager III		Senior Application Developer III, Software/Computer Consultant III
\$ 165.00	Project Manager II Project Engineer II	Survey Manager II Project Surveyor II	Landscape Architect II LA Project Manager II	GIS Manager II	Construction Administrator II	Senior Application Developer II, Software/Computer Consultant II
\$ 150.00	Project Manager I Project Engineer I	Survey Manager I Project Surveyor I Survey Party (2–Men)	Landscape Architect I LA Project Manager I	GIS Manager I	Construction Administrator I	Grant Administrator, Senior Application Developer I, Software/Computer Consultant I
\$ 140.00	Designer IV Engineering Technician IV	Staff Surveyor V Survey Field Supervisor	Landscape Designer IV	GIS Analyst IV	Field Representative V	Application Developer IV
\$ 130.00	Designer III Engineering Technician III	Staff Surveyor IV	Landscape Designer III	GIS Analyst III	Field Representative IV	Application Developer III
\$ 120.00	Designer II Engineering Technician II	Staff Surveyor III	Landscape Designer II	GIS Analyst II		Application Developer II
\$ 110.00	Designer I Engineering Technician I	Survey Party (1–Man) Staff Surveyor II	Landscape Designer I	GIS Analyst I	Field Representative III	Application Developer I, Permit Coordinator II, Admin IV
\$ 100.00	CADD Technician III	Survey Technician III Staff Surveyor I	Landscape Technician III	GIS Technician III	Field Representative II	Permit Coordinator I
\$ 90.00	CADD Technician II	Survey Technician II	Landscape Technician II	GIS Technician II		
\$ 85.00	CADD Technician I	Survey Technician I	Landscape Technician I	GIS Technician I	Field Representative I	Admin III
\$ 80.00						Admin II
\$ 75.00						Admin I
\$ 400.00	Expert Witness					

- 3. When warranted, overtime will be charged for any non-salary employees. Overtime hours will be billed at 1-1/2 times the individuals charge rate.
- 4. Direct non-salary (reimbursable) expenses, including printing, reproduction, air travel, lodging, and meals are billed at cost. Travel in company or private vehicles will be billed at the IRS Standard Mileage Rate of \$0.56 per mile and may be revised based on fuel pricing. Outside consultant fees will be billed at 1.15 times the cost.
- 5. All rates and charges are effective through January 1, 2022, including printing, reproductions, materials, and travel and are subject to change at that time. New rates and costs will become immediately effective to contracts in effect at the time of rate changes.

DATE

2/23/2021

QUOTE INFORMATION

BUNC2020000138C631

MD6 42R

Qty: 1

PREPARENT

HUGHES MOTORS, INC. 6841 BULLDOG DR

CHARLESTON SC 294064733

PREPARED FOR

ISLE OF PALMS CITY (INC) 1303 PALM BLVD


> ISLE OF PALMS SC 294512232

16FT FLATBED DUMP

PROPOSAL





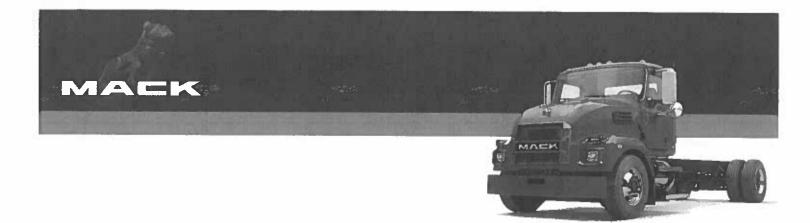

Mr. Donnie Pitts

DATE 2/23/2021

QUOTE INFORMATION

BUNC2020000138C631

MD6 42R Qty: 1

PREPARED BY

HUGHES MOTORS, INC. 6841 BULLDOG DR CHARLESTON SC 294064733

PREPARED FOR

ISLE OF PALMS CITY (INC) 1303 PALM BLVD

> ISLE OF PALMS SC 294512232

Thank you for giving us this opportunity to provide a quote.

This proposal contains the complete specification and performance details of the Mack model configured for your application. Every proposed spec from Mack is prepared with lowest total cost of ownership and highest return on investment as the key objectives for our customers.

This reflects Mack's focus on application excellence to deliver uptime and fuel economy, reduced maintenance, driver satisfaction, productivity and high resale value. The enclosed spec and recommendations have been carefully designed to meet all these objectives.

Beyond the technical specifications contained in this proposal, it's important to remember that each Mack truck is backed by Mack Connect, the industry's leading uptime and productivity solution, plus a coast-to-coast network of dealer service locations. I think that after reviewing this proposal you will realize why Mack is "The American Truck You Can Count On."


I look forward to meeting with you and to discuss any questions you might have regarding this proposal.

Yours sincerely

William Peck

BILL PEEK

HUGHES MOTORS, INC.

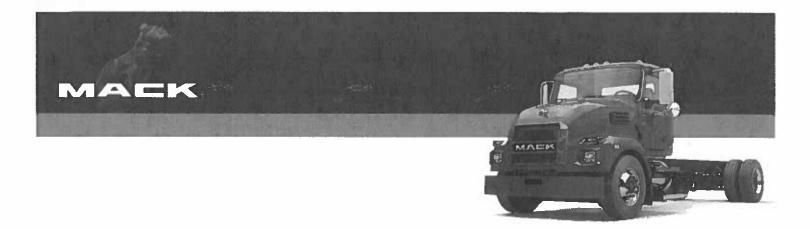

PRICING SUMMARY

MD6 42R

VEHICLE PRICE

\$81,884.00

EXTERNAL LOCALS

16ft Flatbed dump with barn door gate and electric tarp system

\$14,876.00

TOTAL VEHICLE PRICE

\$ 96,760.00

TAX SUMMARY

SC IMF

\$500.00

TOTAL TAX

\$500.00

TOTAL SELLING PRICE (PER UNIT)

97,260.00

ISLE OF PALMS CITY (INC)


DATE

William Peck

2/23/2021 DATE

The price above includes a 16' flatbed dump per attached body specifications from Double A Body Builders in Pamplico S.C. Please review body specs for accuracy.

This is a NON CDL chassis

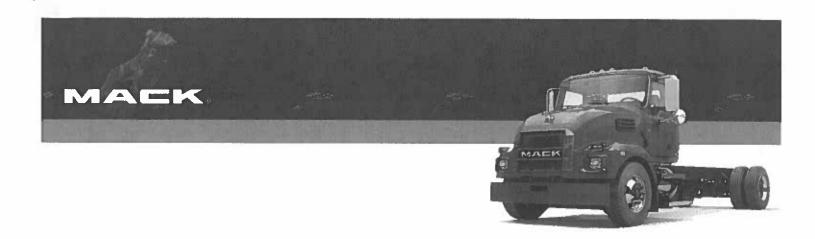

TECHNICAL SPECIFICATION

MD6 42R

20210104

BUNC2020000138C631

APPL	ICATION PACKAGES	DESCRIPTION
S	CHASSIS HEIGHT	DOCK HEIGHT
CUST	OMER/VEHICLE INFO	DESCRIPTION
S	CHASSIS (BASE MODEL)	MD642 - 42R MEDIUM DUTY, CLASS 6 w/ 6.7L, (MAX 25,995lbs GVWR)
S	ASSEMBLY PLANT	FACTORY USA (RV, MACK)
	VEHICLE USE & BODY/TRAILER TYPE	DUMP TRUCK
	VEHICLE VOCATION	PICKUP & DELIVERY / SHORT HAUL SERVICE
S	CUSTOMER FLEET SIZE	DEALER FLEET WITH LESS THAN 25 VEHICLES IN OWN FLEET OF ANY VEHICLE BRAND
	TYPE OF SERVICE	MUNICIPAL.
s	WARRANTY REGISTRATION LOCATION	US - WARRANTY REGISTRATION LOCATION
S	INITIAL REGISTRATION LOCATION	ALL 50 STATES, CARB ENGINE EMISSION (US17 / US21 / ZERO EMISSION)
s	LANGUAGE-PUBS/DECAL/SIGNS	ENGLISH
S	TERRAIN GRADE	CITY, STARTING GRADES<6%
s	LOADING SURFACE	ASPHALT LOADING AND / OR UNLOADING SURFACE
	VEHICLE MODEL YEAR	2022 MODEL YEAR
ENGI	NE & TRANSMISSION	DESCRIPTION
	ENGINE PACKAGE, COMBUSTION	ISB6.7-280 D CUMMINS 280HP @ 2600RPM (GOV) 660 LB-FT, US21
	TRANSMISSION	2500 RDS 6 SP-ALLISON RUGGED DUTY SERIES GEN 5 W/PROGNOSTICS (WITH PTO PROVISIONS)
S	FUELSENSE CALIBRATION	ALLISON FUELSENSE BASIC, NEUTRAL AT STOP
ENGI	NE & TRANSMISSION EQUIPMENT	DESCRIPTION
ENGI	NE & TRANSMISSION EQUIPMENT ENGINE BRAKE TYPE	DESCRIPTION ENGINE BRAKE
ENGI		
ENGII	ENGINE BRAKE TYPE	ENGINE BRAKE
	ENGINE BRAKE TYPE CRUISE CONTROL	ENGINE BRAKE CRUISE CONTROL

3 of 7

ISLE OF PALMS CITY (INC)

HUGHES MOTORS, INC.

TECHNICAL SPECIFICATION (cont.)



720	& TRANSMISSION EQUIPMENT	DESCRIPTION	200
3	POWER TAKE OFF CONTROL	WITHOUT ENGINE BLOCK HEATER	
	POWER TAKE OFF CONTROL	POWER TAKE OFF TRANSMISSION CONTROL, PREP KIT F/SINGLE PTO	
AXLE &	SUSPENSION	DESCRIPTION	
3	FRONT AXLE	10,000LB MERITOR MFS+ 4500 KG	
S	SPRINGS - FRONT	MACK TAPERLEAF 10000# (4500 KG) GROUND LOAD RATING	
s	FRONT AXLE BRAKES	MERITOR "S" CAM TYPE 16.5" x 5" Q+	
	REAR AXLE - SINGLE	21000# (9525 kg) MERITOR MS-21-13X, (W/O DIFF LOCK) CASING 11.0mm	
	REAR SUSPENSION - SINGLE	21000# (9525kg) MULTILEAF	
	SUSPENSION LEVELLING DEVICE	WITHOUT SUSPENSION LEVELLING DEVICE	
S	BRAKES - REAR	MERITOR "S" CAM 16,5"x7" Q+	
S	REAR AXLE RATIO	RATIO 5.57, REAR AXLE	
CHASSI	S EQUIPMENT	DESCRIPTION	
S	IDLE EMISSION CERTIFICATION	IDLE EMISSION CERTIFICATION, CARB 08	
	DPF DIESEL PARTICULATE FILTER	CUMMINS SINGLE MODULE E.A.T.S. RH SIDE UNDER CAB US17 (7L over	271HP \ 9L over 351Hf
S	EXHAUST	only!!) UNDERFRAME RIGHT SIDE INBOARD MOUNTED	
	BODY BUILDER MODULE	EL PREP KIT, TMC RP1404 EL. INTERFACE NO BODYBUILDER MODULE	
s	ELECTRICAL RECEPT, AUX POWER	WITHOUT ELECTRICAL PREPARATION FOR LIFTGATE	
FRAME	EQUIPMENT & FUEL TANKS	DESCRIPTION	
	WHEELBASE	186" Wheelbase (123" CA) 60" After-frame	
S	FRAME RAILS	STEEL - 260MM X 70MM X 7MM (10.24" X 2.75" X 0.275"); RBM 1,370,000	LB-IN
S	PRIMARY FUEL FILTER	FUEL FILTER & WATER SEPARATOR	
S	FUEL TANK - LH	50 GALLON (190 L) 22" ALUMINUM ROUND	
CAB INT	ERIOR	DESCRIPTION	
S	GAUGES - UNIT OF MEASURE	U.S. UNITS (PREDOMINANT)	
	BACK-UP ALARM	BACK-UP ALARM	
S	AIR RESTRICTION INDICATOR	MECHANICAL, GRADUATED, ON FILTER	
S	DAYTIME RUNNING LIGHTS	DRL WHEN ENGINE RUNNING & PARK BRAKE OFF	
S	FIRE EXTINGUISHER	HAND FIRE EXTINGUISHER 1.1 KG (2.5LB) ENGLISH DECAL, ABC	
	AUDIO SYSTEM	RADIO, AM/FM, MP3, WEATHER BAND	
S	AUDIO INTEGRAT. PHONE HANDSFRE	AUDIO INTEGRATED HANDSFREE PHONE, BLUETOOTH	
S	AUDIO COMMUNICATION CONNECTOR	AUDIO COMMUNICATION CONNECTOR, USB AUDIO	
S	COMMUNICATION EQUIPMENT	FACTORY INSTALLED GEOTAB FLEET MANAGEMENT SYSTEM	
S	DRIVER SEAT SUPPORT	MACK DRIVERS SEAT, AIR SUSPENDED	
S	DRIVERS SEAT UPHOLSTERY	DRIVERS SEAT UPHOLSTERY, VINYL	
S	PASSENGER SEAT SUPPORT	FIXED PASSENGER SEAT	
S	PASSENGERS SEAT UPHOLSTRY	PASSENGERS SEAT UPHOLSTERY, VINYL	
CAB EX	TERIOR	DESCRIPTION	
	MIRRORS - EXTERIOR	HEATED AND MOTORIZED MIRRORS BOTH SIDES, BLACK (Anthem mirror	1






WHEE	LS & TIRES	DESCRIPTION
s	TIRES BRAND/TYPE - FRONT	11R22.5 G BRIDGESTONE R268 ECOPIA (12350 lbs) (Total for QTY = 2)
	GHG STEER TIRE CATEGORY (PAWS)	GHG STEER TIRE CATEGORY, LOW ROLLING RESISTANCE
S	WHEELS - FRONT	22.5x8.25 ACCURIDE, POWDER COATED WHITE STEEL DISC (Total for QTY = 2)
	FRONT AXLE TIRE & WHEEL QUANTITY	TWO FRONT TIRES & WHEELS
	TIRES BRAND/TYPE - REAR	11R22.5 G BRIDGESTONE M760 ECOPIA (23360 lbs) (DRIVE ONLY) (Total for QTY = 4)
	GHG DRIVE TIRE CATEGORY (PAWS)	GHG DRIVE TIRE CATEGORY, BASIC ROLLING RESISTANCE
S	WHEELS - REAR	22.5x8.25 ACCURIDE, POWDER COATED WHITE STEEL DISC (Total for QTY = 4)
	REAR AXLE TIRE & WHEEL QUANTITY	FOUR REAR AXLE TIRES & WHEELS

PAINT		DESCRIPTION
S	PAINT COLOR - FIRST COLOR	GLACIER WHITE; P3029
BASE	WARRANTY & PURCHASED COVERAGES	DESCRIPTION
S	ENGINE TOWING WARRANTY	CUMMINS ENGINES (Contact Cummins for Standard Warranty and Extended Coverage Details)
S	MACK ONECALL BUNDLE	12 MONTH - ASIST AND MACK ONECALL
S	VEHICLE WARRANTY TYPE	NORMAL DUTY WARRANTY CLASSIFICATION
S	BASIC CHASSIS COVERAGE	CHASSIS PLAN 24 MO/UNLIMITED MI NORMAL DUTY PROTECTION PLAN
s	ENGINE WARRANTY	CUMMINS ENGINES B6.7 (Contact Cummins for Standard Warranty and Extended Coverage Details)
S	EMISSION COMPONENT COVERAGE	CUMMINS ENGINES (Contact Cummins for Standard Warranty and Extended Coverage Details)
s	TRANSMISSION WARRANTY	ALLISON TRANSMISSIONS (Contact Allison Transmission for standard warranty and extended coverage data
s	AIR CONDITIONING WARRANTY	AIR CONDITIONING STANDARD COVERAGE (Sealed System Only) 24 MONTHS UNLIMITED MILEAGE
s	CHASSIS TOWING WARRANTY	STANDARD CHASSIS TOWING 90 DAYS OR 5,000 MILES
S	PARTNERED SERVICES	GEOTAB FOR MACK TRUCKS - 12 MONTH



VEHIC	CLE SPECIFICATION/CALCUL	ATED PERFORMANCE SUI	MMARY	N 100 (80 3
Description · · ·	Sales,Code	Dwg Ref	Length ₅	UOM
Front Frame Extension	N/A	FE	0,0	INCHES
Bumper to Front Axle	N/A	BA	40.0	INCHES
Wheelbase	N/A	WB	186.0	INCHES
Rear Overhang	N/A	ОН	59.6	INCHES
Overall Length	N/A	OL	285.7	INCHES
Bumper to Back of Cab	N/A	BBC	103.0	INCHES
Eff. Bumper to Back of Cab	N/A	EBBC	103.0	INCHES
Eff. Cab to Rear Axle	N/A	ECA	123,0	INCHES
Eff. Front Axle to Back of Cab	N/A	EAC	63.0	INCHES
Eff. Cab to End of Frame	N/A	ECEF	182.7	INCHES
Unladen 5th Wheel Height	001AA3	5W	0.0	INCHES
Unladen Frame Height	N/A	FH	40.9	INCHES
Cab Height	N/A	СН	69.1	INCHES
Overall Height	N/A	OVH	110.0	INCHES
Driver CG	N/A	DCG	59.1	INCHES
Second Front Axle Spacing	001AA3	SFAS	0.0	INCHES

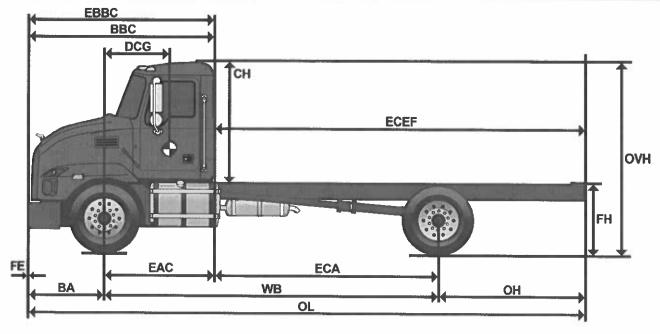


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DOUBLE A BODY BUILDERS • www.doubleabody.comPO Box 363 • 1407 N. Pamplico Highway • Pamplico, SC 29583 • Phone (843) 493-5021 • Fax: (843) 493-1995

QUOTE TO: Hughes Mo Bill Peek 843-200-3			DATE Q	UOTED		01/25/2	21
billp@bunchtruckg			TRUCK	ARRIVAL DATE:			
			ESTIMA	ATED COMPLETION DATE:			
COLOR OF BODY:				D 8Y:		in 843-687-	7643
				ACT MATCH IS NOT G			
MAKEMac	:k	_VIN#			MODEL#	MD6 N	fled Duty
YEAR			TRANSMISSION		:0	KEY#:	
BODY TYPE	SIZE	TYPE	PRICE	ACCESSORIES			PRICE
Flatbed				25 Ton Pintle Ho			
Flatbed Dump	16'	twin tele	8,450.00	15 Ton Pintle Ho	ok		
· · · · · · · · · · · · · · · · · · ·				Reece Hitch			
Contractor Dump				Multi-Hitch Pint	le Ball Comb	0	
Utility Body				RV Plug			
Lift Gate				6 Pin Round			
✓ Headboard		Standard	450.00	Other Plug			
4				Glad Hands			
Sides	48"	Perm	1,525.00	Dual Wiring			
Tailgate	48"	Barn	575.00	Deliver	to Hugh	es Motor	
1/2 Cab Shield		<i>i</i>	300.00				
Gooseneck							
Slide Track				TOOLBOX			
Binders •	Quantity≏			" Steel \$	}	3 <i>4"</i> Al	um ¢
Hammer Tarp							um. \$
₩ Bullet Tarp	Electric	Alum tarp	1,600.00	1 36" Steel \$ 4	76.00	36" Al	um. \$
5000 XLC				48" Steel \$		48" Al	um. \$
5000 XGL				60" Steel \$		60" Al	um. \$
2000 X				FRAME MODIFICATIO	N		
2000 SR				Stretch \$		Short	en \$
Air PŦO				Target CA =			
Standard PTO	<u></u>			NOTES:		<u> </u>	
Auto PTO	ho	ot shift	1,500.00		ustomer	: Isle of Pal	ms
Electric Dump							
Console Control				Equipment	Subtot	al:	14,876.00
Air Pump			•	TAX EXEMPT NO	✓ S0	Sales Tax	en esagement
Electric Brake				TOTAL QUOTE:		14,876	.00
						,	





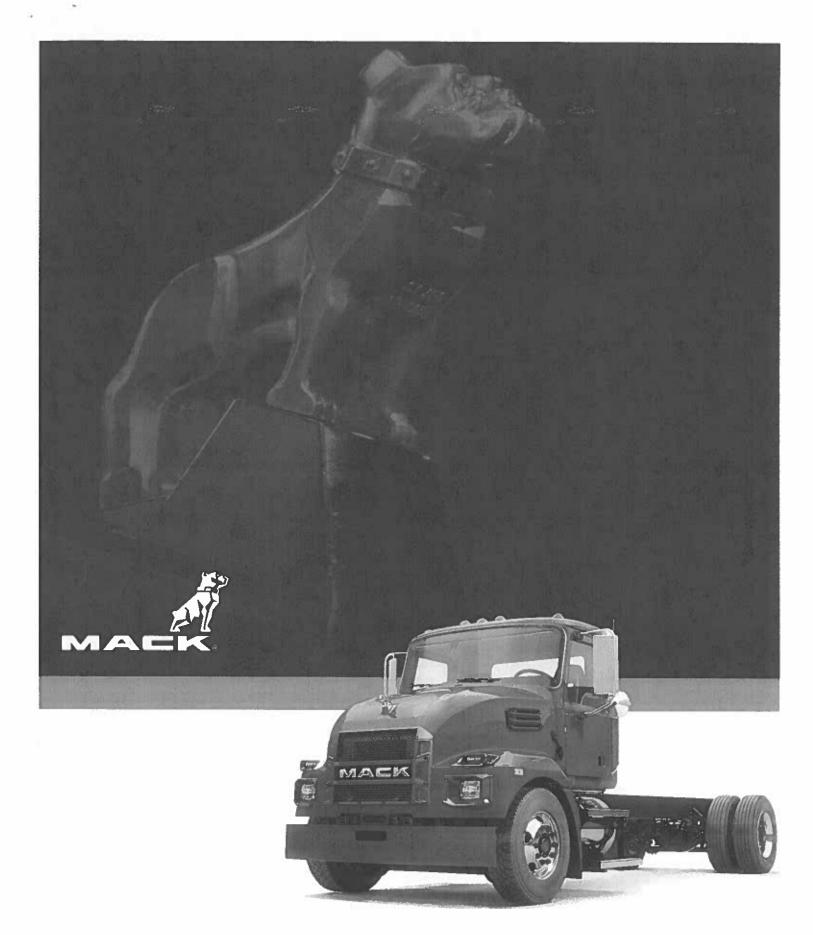

HUGHES MOTORS, INC.

6841 BULLDOG DRIVE 29406 P.O. BOX 62709 • CHARLESTON, SC 29419 TELEPHONE: (843) 553-6410

FAX NUMBER: (843) 569-1770 TOLL FREE: 1-800-214-MACK WWW.BUNCHTRUCKGROUP.COM



Mack MD6 References

3/16/2021

Bunch Leasing Company

Jay Rossitz

(585)975-9192

- 2) daily rental units
- 1) flatbed truck and 1) van body truck

Aquatica Pools and Spa's

Thiago Silva

(843)442-9177

2) flatbed dumps

Town of Mt Pleasant

Jody Peele

(843)297-1599

3) scow dumps and 1) asphalt patch truck

Product Information



0021800

MD642 - 42R MEDIUM DUTY, CLASS 6 w/6.7L (002GH2)

Affects: Related:

Updated:

January 28, 2020



Drawing on MACK's rich history and knowledge in manufacturing world class tough trucks, the MD6 was designed from the ground up to be a class leader. Every piece of the truck was analyzed to provide what the customer needs to succeed with this Class 6, medium-duty truck.

The MACK MD6, 4x2 configuration is well suited for dry van, refrigerated, fuel/water/waste, towing and recovery, and dump/utility bodies. The MD6 comes powered by the industry leading Cummins B6.7 diesel engine and is matched with the Allison 2500HS six speed transmission with FuelSense™ 2.0 - fuel saving neutral-at-stop technology. Multiple horsepower ratings are available along with an option for the Allison 2500RDS when customers require a power-take-off (PTO).

Sharing some interior components from the MACK Granite, the MD6 cab is a proven solution that takes advantage of economies of scale and maintains the function, comfort and operator oriented environment standard with MACK. Features like the flat bottom steering wheel with tilt and telescoping column, instrument cluster with driver information display and switches for lighting and power windows. The cab dash and floor space were redesigned to accommodate optional three-person seating and to maximize the overall layout and interior space.

The industry has trusted their toughest jobs to MACK for generations. Built in America from light, durable and quality materials, our trucks stand up to the rigors of customer's demands.

The follow pages outline standard truck features. Please refer to the MACK Sales System (MSS) for truck options and additional feature information.



WARRANTY SUMMARY	MD Series Models MD6, MD7 Distribution, Short Haul or P&D		
Typical Vocations			
Axle Configuration	4 x 2		
Basic Coverage	24 months/unlimited miles*		
Batteries	12 months/unlimited miles		
Chassis Towing	90 days or 5,000 miles (8 047 KM), whichever occurs first*		
Air Conditioning	24 months/unlimited miles – air conditioning (sealed system only)		
Engine/Emission	Warranty coverage provided by Cummins.		
Transmission	Warranty coverage provided by Allison.		
Driveline, Rear Axle, Front Steer Axle	24 months/unlimited miles*		
Cab Structure & Internal Cab Corrosion	60 months/unlimited miles*		
Frame Rail/ Crossmembers	60 months/unlimited miles*		
Noise Emission	Life of vehicle*		

*See complete warranty certificate for details. Shaded areas indicate optional equipment.

All illustrations, specifications and descriptions in this specification are based on the latest product information available at the time of this publication. The right is reserved to make changes in price, materials, equipment, design, specifications, diagrams and models, and to discontinue models of equipment at any time, without notice and without incurring any obligation whatsoever. For more information on additional options and accessories, contact Mack Trucks, Inc. (www.macktrucks.com).

UPTIME SUMMARY	MD Series Models MD6, MD7		
Mack OneCall	12 months		
Mack ASIST	12 months		
Geotab Basic	12 months		
PURCHASE OPTIONS			
Mack OneCall	24-60 months, in 12 mo. increments		
Mack ASIST	24-60 months, in 12 mo. increments		
Geotab Basic	24-60 months, in 12 mo. increments		
Geotab Plus	12-60 months, in 12 mo. increments		
OTHER OPTIONS			
Allison Upgrade	Fuel Sense 2.0 MAX		
Battery Shut Off	Under cab, passenger side		
Engine Block Heater			
Air Filter Indicator	Under hood, restriction indicator mounted to air cleaner		
PTO Preparation Kit	Harness & switch kit		
Cab Mirrors	Chrome finish & convex mirror heated & motorized		
Passenger Seat	Two-person bench seat w/vinyl & under seat storage		
Drivers Seat Trim	Modura cloth upgrade seat upholstery		
Passenger Seat Trim	Modura cloth upgrade seat uphoistery		
Passenger Bench Trim	Modura cloth upgrade seat upholstery		







GENERATIONS OF EXPERIENCE.

- 35+ years of market-leading production
- 12M+ B-series engines produced globally
- 2.25M+ miles of B and L pre-production experience

DELIVERS UPTIME, BIG TIME.

- Full year base warranty extension in 2017 to 3 year unlimited mileage
- Further peace of mind due to confidence in ultra-reliable product
- 5% average fuel economy improvement on Performance ratings
- 8.5% average fuel economy improvement on Efficiency ratings

An unbeatable legacy means a deep understanding of customers' duty cycles and needs. No matter the application, with the B6.7 you get the lowest cost of operation and maximum uptime.


A LONG HISTORY OF INNOVATION AND RELIABILITY.

American-designed and globally embraced, the MidRange market leader has a proven stable architecture that has evolved to fit customer power needs.

- ■35 years of parent bore design
- 20 years of 24 valves
- 15 years of VGT®, EGR and HPCR
- 11 years of 6.7L displacement
- 10 years of aftertreatment

FOCUS ON FUEL ECONOMY.

Improvement over 2013 ISB6.7

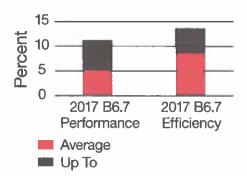

Engine Model	Power HP (kW)	Peak Torque lb-ft (N+m) @ rpm
325-280	HP Performa	nce Ratings
B6.7 325	325 (242)	750 (1017) @ 1800
B6.7 300	300 (224)	660 (895) @ 1600
B6.7 280	280 (209)	660 (895) @ 1600
260-20	00 HP Efficien	cy Ratings
B6.7 260	260 (194)	660 (895) @ 1600
B6.7 250	250 (186)	660 (895) @ 1600
B6.7 240	240 (179)	560 (759) @ 1600
B6.7 220	220 (164)	600 (813) @ 1600
B6.7 220	220 (164)	520 (705) @ 1600
B6.7 200	200 (149)	520 (705) @ 1600

The flexibility to uprate with a hardware change only necessary between families.

Peace of Mind



3 Year / unlimited mile base warranty

- Confidence in ultra-reliable product
- Further peace of mind, beyond proven dependability
- 100% Coverage for:
 - Parts and labor on warrantable failures
 - Aftertreatment
 - · Consumables used in the repair
- Travel / Towing is covered
- All with no deductible

Product Information



252 MERITOR MS-17-13X, MS-19-13X and MS-21-13X

(W/O DIFF LOCK), CASING 9.5mm


Related:

Rear Suspension Single (260)

Updated:

December 25, 2019

The MS-13X[™] single rear drive axle for medium-duty applications is designed for maximum durability and weight savings. The 13X[™] is ideal for Class 6 and 7 trucks. Equipped with Meritor Q+ drum brakes, it has a gross axle weight rating (GAWR) ranging from 17,000 to 21,000 pounds.

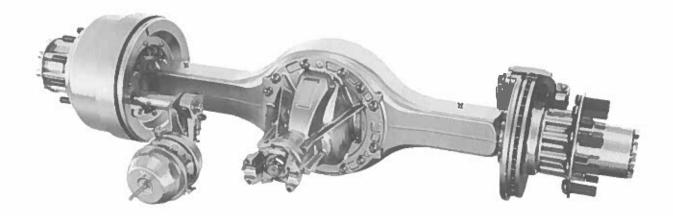

Features

- Up to 59 lbs. lighter than MS-14X carrier
- Utilizes same housing as 14X designs
- Power dense gearing design maximizes axle efficiency

MS-13X Specifications			
Axle Model	MS-17-13X	MS-19-13X	MS-21-13X
Sales Symbol	2522033	2522035	2522037
GAWR	17,000 lbs.	19,000 lbs.	21,000 lbs.
Ratios	4.33 - 5.89*	4.33 - 5.89*	4.33 - 5.89*
Wall Thickness @ Spring Perch	.37" (9.5 mm)	.37" (9.5 mm)	.37" (9.5 mm)

^{*}Refer to the MACK Sales System (MSS) for all available ratios

Product Information



2402032 10,000LB MERITOR MFS+™ 4500 KG (2400R0) 2402033 12,000LB MERITOR MFS+™ 5400 KG (2400S0)


Related:

Front Suspension

Updated:

December 25, 2019

The new Meritor® MFS+™ features the patented, market-leading technology of MFS™ Series front axles. The system saves weight while improved performance and packaging reduces service time. MFS™ Series axles continue a long-running tradition of great packaging flexibility, optimized performance and reliability.

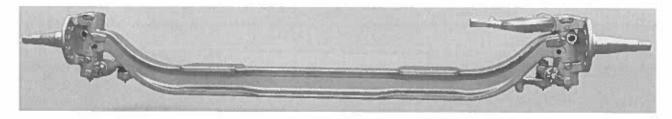

Features

- · Optimized beam design provides a stronger and lighter weight package
- · Integrated torque plate and tie rod arms reduce weight and increase payload
- Easy-Steer™ bushing offers superior steering
- Lower assembly time and maintenance costs
- Packaged with Meritor Q+™ drum brakes



Devri Detoma, P. E. Construction Project Manager II Transportation Development 843.202.6144
Fax: 843.202.6152
ddetoma@charlestoncounty.org
Lonnie Hamilton III Public Services Building
4045 Bridge View Drive, Suite C204
North Charleston, SC 29405

April 07, 2021

The Honorable Jimmy Carroll Mayor City of Isle of Palms P.O. Box 508 Isle of Palms, SC 29451

Subject:

Project Requests - FY 2022 Charleston County Transportation Committee (CTC)

"C"Fund Projects

Dear Mayor Carroll:

The Public Works staff once again will be preparing lists of resurfacing and new construction projects to be funded under the FY 2022 CTC road improvement program. Prioritizing the resurfacing of existing paved roads will be done utilizing our computerized Pavement Management System which is based on the technical evaluation of the overall condition of each road. This eliminates the need for requests for resurfacing of specific roads. If you should have questions regarding the County's resurfacing program or the Pavement Management System, you may contact County staff at (843) 202-7600.

Historically, the annual CTC allocation for new construction projects (e.g., rocking, paving, or improving earth roads; road drainage; road signage; traffic calming measures; striping; improvements to intersections; sidewalks and bike paths) ranges from \$1 million to \$1.5 million in "C" Funds. The CTC has adopted a policy that allows its funds to be spent only on public right-of-way. If new or additional right-of-way is involved for construction, the requesting entity will be required to obtain the needed right-of-way (this policy does not apply to the TST Annual Allocation Program).

We recognize that priorities within your jurisdiction may change from year to year. Therefore, previously requested projects are not carried over from previous years. We ask that all construction project requests be prioritized each year and that you include a detailed description of the project scope, location, and estimated cost (when possible). Requests will be evaluated on an individual merit basis. Each request must meet certain criteria, such as acceptance by a government agency for perpetual maintenance, existing right-of-way, etc. For traffic calming

requests, please provide documentation that the project meets all applicable guidelines and has been formally approved by the local government agency. Project requests may compete against each other, but will be considered and evaluated separately on individual merit by CTC members and budgeted accordingly.

We are asking that your request(s) for proposed new construction projects be forwarded to us on or <u>before May 28, 2021</u>. We ask that you submit a statement from the governmental entity having jurisdiction accepting perpetual maintenance responsibilities for the project if selected. Please keep our funding limits in mind as you prepare your list of requested projects.

County staff members may contact you for additional information as they complete the processing of the requested projects.

If you have any questions regarding details of the program or if any questions arise in the development of your project requests, please contact me at (843) 202-6144.

Sincerely,

Devri DeToma, P.E.

Charleston CTC Program Coordinator

Den Dettin

W. O'Brien Limehouse, Charleston CTC Chairman

cc: